

ORDINANCE NO. 18-06-25

**AN ORDINANCE TO AMEND THE UNIFIED DEVELOPMENT ORDINANCE,
A PART OF THE COMPREHENSIVE PLAN OF THE CITY OF NOBLESVILLE,
HAMILTON COUNTY, INDIANA**

Document Cross Reference Nos. 2009005087, 2010022173, 9909904880, 2009070777, 2016014960, 2019066132

This Ordinance (the "MontClaire PD Ordinance" or "PD Ordinance") amends the Unified Development Ordinance for the City of Noblesville, Hamilton County, Indiana (the "UDO"), enacted by the City of Noblesville (the "City") under authority of Indiana Code § 36-7-4-600, et seq., as amended.

WHEREAS, the Plan Commission of the City of Noblesville (the "Plan Commission") conducted a public hearing on docket number LEGP 0264-2024 at its May 19, 2025 meeting, as required by law, in regard to the application (the "Petition") filed by MI Homes of Indiana, an Indiana limited partnership (the "Developer") concerning a change of zoning of certain property described in Exhibit A attached hereto (the "Real Estate" which is also referred to herein as the "District") and the adoption of a preliminary development plan to be known, collectively with attached Exhibits, as the "MontClaire Preliminary Development Plan", as further described in Section 4 below (the "Preliminary Development Plan"); and,

WHEREAS, the Plan Commission has sent a Favorable Recommendation for adoption of said amendment with a vote of nine (9) AYES and one (1) NAY to the Common Council of the City of Noblesville Hamilton County, Indiana (the "Common Council");

NOW, THEREFORE, BE IT ORDAINED by the Common Council, meeting in regular session, that it hereby adopts this MontClaire PD Ordinance as an amendment to the UDO and the Official City of Noblesville Zoning Map (the "Zoning Map") to establish this Planned Development Overlay District (the "District") to read as follows:

Section 1. Applicability of Ordinance.

- A. The Zoning Map is hereby amended to change the zoning of the Real Estate from "R3" Residential to "R3/PD" Residential Planned Development, which is to be known as the MontClaire Planned Development (the "District").
- B. The District's underlying zoning district shall be R3 Residential (the "Underlying District"). Development in this District shall be governed entirely by (i) the

provisions of this MontClaire PD Ordinance and its exhibits, and (ii) those provisions of the UDO in effect as of the date of adoption of this Ordinance, and applicable to the Underlying District, except as modified, revised, supplemented or expressly made inapplicable by this Ordinance. Cross-references to “Article”, “Part”, “Section” and “Subsection” in this Ordinance shall refer to the corresponding Article, Part, Section and Subsection as specified and referenced in the UDO.

- C. All provisions and representations of the UDO that conflict with the provisions of this MontClaire PD Ordinance and its exhibits are hereby rescinded as applied to the Real Estate and shall be superseded by the terms of this MontClaire PD Ordinance.

Section 2. **Definitions.** The general rules of construction set forth in Article 2 of the UDO and the definitions set forth in this Ordinance shall apply to the regulations of this Ordinance. Words not defined herein but defined in the UDO shall be interpreted in accordance with the UDO definition.

Section 3. **Permitted Uses.**

- A. All uses permitted in the Underlying District shall be permitted within the District; however, the maximum number of Dwelling Units shall not exceed one hundred and thirty-six (136).
- B. Accessory Uses and Accessory Structures customarily incidental to any permitted use shall be permitted.

Section 4. **Preliminary Development Plan.**

- A. Full sized, scaled development plans are on file with the City’s Planning and Development Department with a revision date of April 24, 2025. What is attached hereto as **Exhibit B** is a general representation of the full-sized plans and **Exhibit B**, together with the full-sized plans, shall be collectively referred to as the “Preliminary Development Plan”.
- B. The Preliminary Development Plan is hereby incorporated herein and approved. Pursuant to Article 8 of the UDO, the Preliminary Development Plan is intended to establish the basic goals and policies, bulk standards, variations/waivers from the Underlying District and layout of the District.

Section 5. **Bulk Standards.** The bulk requirements applicable to the Underlying District shall be replaced, modified and superseded by the below:

- A. The Minimum Lot Area: Ten Thousand (10,000) Square Feet

- B. Minimum Lot Width measured at the front building setback line:
Eighty-five (85) feet (50' on cul-de-sac lots)
- C. Minimum Lot Frontage at right-of-way: Forty-five (45) feet (30' on cul-de-sac lots)
- D. Maximum Building Height: Thirty-five (35) feet
- E. Minimum Front Yard Setback: Twenty-five (25) feet
- F. Minimum Side yard Setback: Five (5) feet (20 feet – on lot aggregate)
- G. Minimum Rear yard Setback: Twenty (20) feet
- H. Minimum Floor Area: One Story - Eighteen Hundred (1,800) Square Feet
Two Story – Two Thousand (2,000) Square Feet
- I. Maximum Lot Coverage: Sixty (60) percent

Section 6. **Architectural Standards.** The requirements included in Article 8 and the Architectural Design Guidelines adopted by the Noblesville Architectural Review Board, shall not apply, instead the following shall apply to the District:

- A. Homes constructed on the Real Estate shall comply with the Single Family Architectural Standards included under **Exhibit C-1** and **Exhibit C-2**, and as reviewed and approved by the City's Architectural Review Board / PUD/Plat Committee (the "Committee"), at its April 16, 2025 meeting (the "Architectural Standards").
- C. The Architectural Standards are hereby incorporated and approved. All home elevations shall comply with the Architectural Standards. The Director of Planning and Development, including his or her designees, shall review and approve elevations at the time of filing of the Detailed Development Plan or Building Permit for compliance and consistency with the Architectural Standards.
- D. Home elevations that substantially vary from the Architectural Standards shall be submitted to the Committee for approval. The Committee's review of said elevation(s) shall be performed in order to determine its compatibility and consistency with the intended quality and character of the District and the Architectural Standards and Residential Character Imagery.
- E. Elevations (Residential Character Imagery) are hereby incorporated and included under **Exhibit D** (Residential Character Imagery) which are representative of the application of the Architectural Standards.

Section 7. **Landscaping and Open Space Standards.** The standards of Article 12, Landscaping and Screening, of the UDO shall apply, except as modified below:

- A. Lot Landscaping. All Lots shall be landscaped with building base and yard plantings as required below:
1. Front, side and rear yards shall be landscaped as illustrated in Exhibit F.
 2. All Dwellings shall have sod installed in the front yard.
 3. Shrubs shall be a minimum of 24”.
- B. Street Trees. Street Trees shall be installed per the planting standards of the UDO.
1. Street Trees in front of lots shall be installed by the builder of the home on the subject lot at the time of home construction.
 2. Street Trees along common area frontages shall be installed by the Developer at the time to installation of Buffer Yard plantings.
- C. Landscape Buffer Yards. The establishment of a Peripheral Yard, as set forth in Article 8, Part H, Section 3.F.2 of the UDO shall not be applied to the Real Estate. Instead, landscape buffer yards shall be provided as illustrated on the Preliminary Development Plan subject to the following:
1. North perimeter of the Real Estate (from Hazel Dell to Mill Creek):
 - a. A minimum twenty (20) foot common area and twenty (20) foot buffer yard shall be required as shown on the Preliminary Development Plan. Four (4) shade trees, fifteen (15) large deciduous shrubs, and six (6) large evergreen shrubs shall be provided per two-hundred (200) linear feet of within the buffer yard in addition to preservation of existing trees as selected by the Developer.
 - b. Planting are not permitted within existing pipeline easements and therefore shall not be required where conflicts exist as shown on the Preliminary Development Plan.
 - c. Two locations including Lots along the north perimeter of the Real Estate shall be permitted a reduction in this requirement to accommodate the lot configuration shown on the Preliminary Development Plan.
 2. South Peripheral Yard: No buffer shall be required along the southeast perimeter of the Real Estate as shown on the Preliminary Development Plan.
 3. Southwest Peripheral Yard (generally along the legal drain): A minimum fifty (50) foot common area including a minimum twenty-five (25) feet of

preservation of existing trees as selected by the Developer subject to review and approval by the Hamilton County Surveyor.

4. Little Chicago Road Peripheral Yard: The east Peripheral Yard shall be a minimum of (30) feet of common area. Three (3) trees, at least two (2) of which shall be shade trees, and thirty-three (33) shrubs, shall be provided per one-hundred (100) linear feet of road frontage.
 5. Mill Creek Road Peripheral Yard: The east Peripheral Yard shall be a minimum of (30) feet of common area. Five (5) trees, at least two (2) of which shall be shade trees and two (2) of which shall be evergreens, and thirty-three (33) shrubs, shall be provided per one-hundred (100) linear feet of road frontage.
 6. Carter Parcel Peripheral Yard: Surrounding the parcel with its north, west, and south perimeter shared with the Real Estate (the "Carter Parcel") there shall be a minimum of twenty (20) feet of Common Area, preservation of existing trees as selected by the Developer, and three (3) trees, at least two (2) of which shall be shade trees, and thirty-three (33) shrubs, provided per one-hundred (100) linear feet of perimeter.
 7. Shrubs: Shrubs shall be a minimum of 24".
- D. Open Space. Open Space shall be a provided substantially in the size, configuration and locations depicted on Sheet C500 of the Preliminary Development Plan. As shown the Common Areas (less pond area) are 37.4 acres resulting in approximately forty (40) percent of the Real Estate where twenty-eight (28) percent is required.
- E. Tree Preservation. The requirements of Article 12, Section 13.B (Tree Preservation) of the UDO shall be applicable to the Real Estate in areas specified as Tree Preservation Easements on the Final Development Plan and notice of the regulation of such standards shall be included in the Declaration of Covenants and Restriction that will be applicable to the Real Estate.
- F. Additional Landscaping. The Developer shall grade and seed the area on the Carter parcel that is currently being farmed at the time of landscape installation within the buffer yard adjacent to the Carter parcel.

Section 8. Parking and Loading Standards. The standards of Article 10, Off-Street Parking and Loading, of the UDO shall apply except as noted below:

- A. The minimum distance between the street right-of-way and the driveway for lots which front more than one public street shall be twenty-five (25) feet and driveways may be placed within five (5) feet from the side lot lines.

Section 9. **Lighting Standards.** The standards of Article 13, Environmental Performance Standards, of the UDO, shall apply, except as modified below:

- A. Photocell controlled light fixtures shall be required on either side of garage doors.

Section 10. **Sign Standards.** The District's signs shall comply with Article 11 of the UDO, except as modified below:

- A. A sign of the design (including area and height) consistent with the sign depicted in **Exhibit E** shall be permitted.

Section 11. **Site Design and Infrastructure Standards.** Unless otherwise stated within this MontClaire PD Ordinance, all public infrastructure within the District shall adhere to the City's standards and design criteria, subject to the following specific waivers that are hereby approved:

- A. The minimum right-of-way radius for a cul-de-sac shall be fifty-one (51) feet.
- B. Corner lots shall be permitted at the minimum Lot Size applicable to the Real Estate but accommodate the required twenty-five foot front setback on both street frontages.
- C. The Centerline Radii for Residential Minor Collectors shall be 150 feet.
- D. The maximum cul-de-sac length shall be seven hundred and fifty (750) feet. This maximum shall require the reduction in length of Street F as shown on the Preliminary Development Plan and potentially the relocation of two (2) Lots. This reduction in street length and relocation of lots shall be reflected on the Detailed Development Plan.
- E. Dedication of right-of-way and the construction of a path outside the frontage of the Real Estate along the west side of Mill Creek Road shall be provided between the existing paths along the frontage of the Promenade Woods subdivision and the Mill Grove subdivision. Notwithstanding the requirements in this Section 11.E, the construction of the path across the Carter Parcel shall be required only if the owner of the Carter Parcel provides dedication on the necessary right-of-way.
- F. The Developer shall enhance stormwater management at the northeast corner of the site to meet Channel Volume Criteria as presented at the May 19th Plan Commission meeting. Plans for this enhancement shall be included on the Detailed Development Plan.









Section 12. Procedures:

- A. **Detailed Development Plan:** Approval of any Detailed Development Plan (“DDP”) shall follow the procedures set out in Article 8 of the UDO, subject to the following clarification:
1. The Director of Planning and Zoning shall approve a Minor Change; and
 2. If a DDP includes a Major Change from the approved Preliminary Development Plan, then, prior to approval of the DDP, The Major Change shall be reviewed and approved by the Technical Advisory Committee and the Plan Commission based upon compliance with the Governing Standards set forth herein and shall be compatible and consistent with the intended quality and character of the District.
- B. **Secondary Plat:** A Secondary Plat shall be submitted for review and approval as part of any approved DDP.
- C. **Major Change.** For purposes of this PD Ordinance, a “Major Change” shall mean: (i) a substantial change to the location of a perimeter entrance as shown on the Preliminary Development Plan; and (ii) significant changes to the drainage management systems, including, but not limited to, BMP’s and legal drains.
- D. **Minor Change.** For purposes of this PD Ordinance, a “Minor Change” shall mean any change that: (i) is not a Major Change; and (ii) is consistent with the intent of this Ordinance and consistent with the quality and character represented in this MontClaire Ordinance for the District.

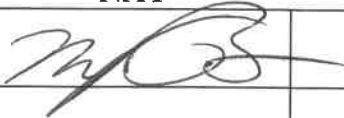Section 13. Effective Date. This MontClaire PD Ordinance shall be in full force and effect from and upon its adoption and publication in accordance with the law.

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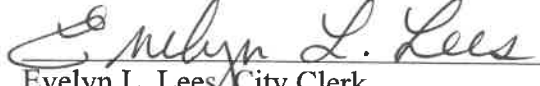
Approved on this 10th day of June, 2025 by the Common Council of the City of Noblesville, Indiana:

AYE		NAY	ABSTAIN
	Mark Boice		
	Michael J. Davis		
	Evan Elliott		
	David M. Johnson		
	Darren Peterson		
	Pete Schwartz		
	Aaron Smith		
	Todd Thurston		
	Megan G. Wiles		

ATTEST:


Evelyn L. Lees, City Clerk

Presented by me to the Mayor of the City of Noblesville, Indiana, this 10th day of June, 2025 at 6:35 P.M.


Evelyn L. Lees, City Clerk

MAYOR'S APPROVAL



Chris Jensen, Mayor

6-10-25
Date

MAYOR'S VETO

Chris Jensen, Mayor

Date

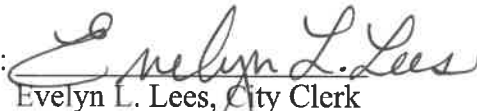ATTEST: 
Evelyn L. Lees, City Clerk



I affirm, under the penalties for perjury, that I have taken reasonable care to redact each Social Security Number in this document, unless required by law: Jon C. Dobosiewicz

Prepared by: James E. Shinaver, attorney at law, NELSON & FRANKENBERGER and Jon C. Dobosiewicz, land use professional, NELSON & FRANKENBERGER. 550 Congressional Blvd, Suite 210, Carmel, IN 46032 (317) 844-0106.

MontClaire PD - PD Ordinance 7 052825

EXHIBIT A

Legal Description

(Page 1 of 3)

A PART OF THE NORTHWEST QUARTER OF SECTION 34, TOWNSHIP 19 NORTH, RANGE 4 EAST LOCATED IN NOBLESVILLE TOWNSHIP, HAMILTON CONTY, INDIANA, DESCRIBED AS FOLLOWS: COMMENCING AT A BRASS PLUG AT THE NORTHWEST CORNER OF THE NORTHWEST QUARTER OF SECTION 34, TOWNSHIP 19 NORTH, RANGE 4 EAST; THENCE ALONG THE WEST LINE OF SAID NORTHWEST QUARTER SOUTH 00 DEGREES 22 MINUTES 15 SECONDS WEST (BASIS OF BEARING) 629.91 FEET; THENCE NORTH 89 DEGREES 32 MINUTES 28 SECONDS EAST 71.61 FEET TO THE EAST RIGHT OF WAY LINE OF LITTLE CHICAGO ROAD AS DESCRIBED IN INSTRUMENT NO. 200300096660 IN THE RECORDER'S OFFICE OF HAMILTON COUNTY; THENCE FOLLOWING THE NEXT NINE (9) COURSES ALONG THE EAST LINE OF SAID INSTRUMENT NUMBER AND CONTINUING ALONG THE EAST LINE OF LAND DESCRIBED IN INSTRUMENT NO. 2004005004 AND 20040036701 IN SAID RECORDER'S OFFICE; 1) SOUTH 00 DEGREES 04 MINUTES 07 SECONDS WEST 360.62 FEET TO A REBAR WITH YELLOW PLASTIC CAP STAMPED "K&G LS FIRM 0141" (HEREINAFTER "CAPPED REBAR") AT THE POINT OF BEGINNING; 2) SOUTH 00 DEGREES 04 MINUTES 07 SECONDS WEST 74.49 FEET TO A "CAPPED REBAR"; 3) SOUTH 01 DEGREES 07 MINUTES 36 SECONDS WEST 197.35 FEET TO A "CAPPED REBAR"; 4) SOUTH 06 DEGREES 29 MINUTES 10 SECONDS EAST 209.41 FEET TO A "CAPPED REBAR"; 5) NORTH 83 DEGREES 21 MINUTES 16 SECONDS EAST 6.55 FEET TO A "CAPPED REBAR"; 6) SOUTH 06 DEGREES 21 MINUTES 55 SECONDS EAST 12.79 FEET TO A "CAPPED REBAR"; 7) SOUTH 83 DEGREES 14 MINUTES 45 SECONDS WEST 6.45 FEET TO A "CAPPED REBAR"; 8) SOUTH 06 DEGREES 27 MINUTES 57 SECONDS EAST 150.37 FEET TO A "CAPPED REBAR"; 9) SOUTH 00 DEGREES 42 MINUTES 00 SECONDS EAST 276.57 FEET TO THE CENTERLINE OF SLY RUN REGULATED DRAIN; THENCE FOLLOWING THE NEXT TWENTY SEVEN (27) COURSES ALONG SAID CENTERLINE; 1) SOUTH 64 DEGREES 13 MINUTES 00 SECONDS EAST 320.10 FEET; 2) SOUTH 60 DEGREES 19 MINUTES 10 SECONDS EAST 42.68 FEET; 3) SOUTH 44 DEGREES 13 MINUTES 04 SECONDS EAST 46.55 FEET; 4) SOUTH 26 DEGREES 08 MINUTES 49 SECONDS EAST 71.33 FEET; 5) SOUTH 51 DEGREES 17 MINUTES 39 SECONDS WEST 21.04 FEET; 6) SOUTH 22 DEGREES 49 MINUTES 09 SECONDS WEST 15.01 FEET; 7) SOUTH 12 DEGREES 22 MINUTES 31 SECONDS EAST 70.06 FEET; 8) SOUTH 30 DEGREES 32 MINUTES 54 SECONDS EAST 8.99 FEET; 9) SOUTH 81 DEGREES 23 MINUTES 41 SECONDS EAST 42.66 FEET; 10) SOUTH 43 DEGREES 28 MINUTES 56 SECONDS EAST 30.26 FEET; 11) SOUTH 64 DEGREES 13 MINUTES 38 SECONDS EAST 29.25 FEET; 12) SOUTH 61 DEGREES 37 MINUTES 07 SECONDS EAST 105.83 FEET; 13) SOUTH 14 DEGREES 25 MINUTES 19 SECONDS EAST 29.17 FEET; 14) SOUTH 41 DEGREES 27 MINUTES 17 SECONDS EAST 34.72 FEET; 15) SOUTH 16 DEGREES 53 MINUTES 01 SECONDS EAST 28.44 FEET; 16) SOUTH 10 DEGREES 44 MINUTES 43 SECONDS WEST 14.43 FEET; 17) SOUTH 25 DEGREES 57 MINUTES 13 SECONDS WEST 14.18 FEET; 18) NORTH 66 DEGREES 37 MINUTES 03 SECONDS WEST 21.81 FEET; 19) NORTH 86 DEGREES 55 MINUTES 51 SECONDS WEST 18.48 FEET; 20) SOUTH 25 DEGREES 18 MINUTES 33 SECONDS WEST 28.41 FEET; 21) SOUTH 45 DEGREES 59 MINUTES 03 SECONDS EAST 71.65 FEET; 22) SOUTH 75 DEGREES 57 MINUTES 17 SECONDS EAST 45.60 FEET; 23) SOUTH 40 DEGREES 34 MINUTES 27 SECONDS EAST 20.10 FEET; 24) SOUTH 01 DEGREES 05 MINUTES 33 SECONDS WEST 19.93 FEET; 25) SOUTH 56 DEGREES 53 MINUTES 16 SECONDS WEST 40.95 FEET; 26) SOUTH 00 DEGREES 46 MINUTES 08 SECONDS WEST 18.91 FEET; 27) SOUTH 46 DEGREES 29 MINUTES 07 SECONDS EAST 29.38 FEET TO THE SOUTH LINE OF THE NORTHWEST QUARTER OF SAID SECTION; THENCE ALONG SAID SOUTH LINE NORTH 89 DEGREES 21 MINUTES 34 SECONDS EAST 552.77 FEET TO A "CAPPED REBAR" ON THE EAST LINE OF THE WEST HALF OF THE NORTHWEST QUARTER OF SAID SECTION; THENCE ALONG SAID EAST LINE NORTH 00 DEGREES 19 MINUTES 56 SECONDS EAST 462.22 FEET TO A "CAPPED REBAR"; THENCE SOUTH 89 DEGREES 41 MINUTES 26 SECONDS EAST 57.75 FEET TO A "CAPPED REBAR"; THENCE NORTH 66 DEGREES 53 MINUTES 59 SECONDS EAST 131.45 FEET TO A "CAPPED REBAR"; THENCE NORTH 89 DEGREES 19 MINUTES 37 SECONDS EAST 371.24 FEET TO A "CAPPED REBAR"; THENCE NORTH 68 DEGREES 03 MINUTES 42 SECONDS EAST 55.49 FEET TO A "CAPPED REBAR"; THENCE NORTH 19 DEGREES 27 MINUTES 22 SECONDS EAST 50.81 FEET TO A "CAPPED REBAR"; THENCE NORTH 24

EXHIBIT A

Legal Description

(Page 2 of 3)

DEGREES 43 MINUTES 26 SECONDS WEST 64.94 FEET TO A "CAPPED REBAR"; THENCE NORTH 40 DEGREES 37 MINUTES 38 SECONDS WEST 55.23 FEET TO A "CAPPED REBAR"; THENCE NORTH 13 DEGREES 52 MINUTES 52 SECONDS WEST 29.39 FEET TO A "CAPPED REBAR"; THENCE NORTH 19 DEGREES 00 MINUTES 05 SECONDS EAST 30.32 FEET TO A "CAPPED REBAR"; THENCE NORTH 65 DEGREES 55 MINUTES 02 SECONDS EAST 44.02 FEET TO A "CAPPED REBAR"; THENCE SOUTH 86 DEGREES 28 MINUTES 15 SECONDS EAST 114.45 FEET TO A "CAPPED REBAR"; THENCE SOUTH 72 DEGREES 39 MINUTES 02 SECONDS EAST 246.91 FEET TO A "CAPPED REBAR"; THENCE NORTH 89 DEGREES 19 MINUTES 37 SECONDS EAST 374.80 FEET TO A MAG NAIL WITH WASHER STAMPED "K&G LS FIRM 0141" (HEREINAFTER "MAG NAIL WITH WASHER") ON THE EAST LINE OF NORTHWEST QUARTER OF SAID SECTION; THENCE ALONG SAID EAST LINE NORTH 00 DEGREES 17 MINUTES 37 SECONDS EAST 658.71 FEET TO A "MAG NAIL WITH WASHER" AT THE SOUTHEAST CORNER OF THE LAND DESCRIBED IN INSTRUMENT NO. 2021045841; THENCE FOLLOWING THE NEXT THREE (3) COURSES ALONG SAID LAND; 1) SOUTH 89 DEGREES 27 MINUTES 21 SECONDS WEST 782.53 FEET TO A T-POST; 2) NORTH 00 DEGREES 17 MINUTES 37 SECONDS EAST 333.94 FEET TO AN IRON PIPE; 3) NORTH 89 DEGREES 27 MINUTES 21 SECONDS EAST 782.53 FEET TO A "MAG NAIL WITH WASHER" ON THE EAST LINE OF SAID QUARTER SECTION; THENCE ALONG SAID EAST LINE NORTH 00 DEGREES 17 MINUTES 37 SECONDS EAST 668.05 FEET TO A "CAPPED REBAR" AT THE SOUTHEAST CORNER OF THE LAND DESCRIBED IN INSTRUMENT NO. 9904483 IN SAID RECORDER'S OFFICE; THENCE ALONG THE SOUTH LINE OF SAID LAND AND THE WESTERLY EXTENSION THEREOF SOUTH 89 DEGREES 33 MINUTES 07 SECONDS WEST 1320.52 FEET TO A "CAPPED REBAR" ON THE EAST LINE OF THE WEST HALF OF THE NORTHWEST QUARTER OF SAID SECTION; THENCE ALONG SAID EAST LINE SOUTH 00 DEGREES 19 MINUTES 56 SECONDS WEST 350.24 FEET TO A POINT ON THE SOUTH LINE OF THE LAND DESCRIBED IN INSTRUMENT NO. 2010022173 IN SAID RECORDER'S OFFICE; THENCE FOLLOWING THE NEXT FOUR (4) COURSES ALONG THE SOUTHERLY LINE OF SAID LAND; 1) SOUTH 71 DEGREES 31 MINUTES 16 SECONDS WEST 264.17 FEET TO A REBAR; 2) NORTH 00 DEGREES 19 MINUTES 24 SECONDS EAST 50.53 FEET TO A REBAR; 3) NORTH 60 DEGREES 27 MINUTES 32 SECONDS WEST 79.98 FEET TO A REBAR; 4) SOUTH 89 DEGREES 32 MINUTES 28 SECONDS WEST 739.35 FEET TO A REBAR ON THE EAST LINE OF THE LAND DESCRIBED IN INSTRUMENT NO. 2009070777 IN SAID RECORDER'S OFFICE; THENCE ALONG SAID EAST LINE SOUTH 47 DEGREES 28 MINUTES 46 SECONDS WEST 189.70 FEET TO A REBAR AT THE NORTHEAST CORNER OF THE LAND DESCRIBED IN SAID INSTRUMENT NO. 20100022173; THENCE FOLLOWING THE NEXT TWO (2) COURSES ALONG SAID LAND; 1) SOUTH 00 DEGREES 04 MINUTES 07 SECONDS WEST 193.98 FEET TO A "CAPPED REBAR"; 2) NORTH 89 DEGREES 55 MINUTES 53 SECONDS WEST 50.00 FEET TO THE POINT OF BEGINNING, CONTAINING 92.31 ACRES, MORE OR LESS.

EXHIBIT A

Depiction of Legal Description
(Page 3 of 3)


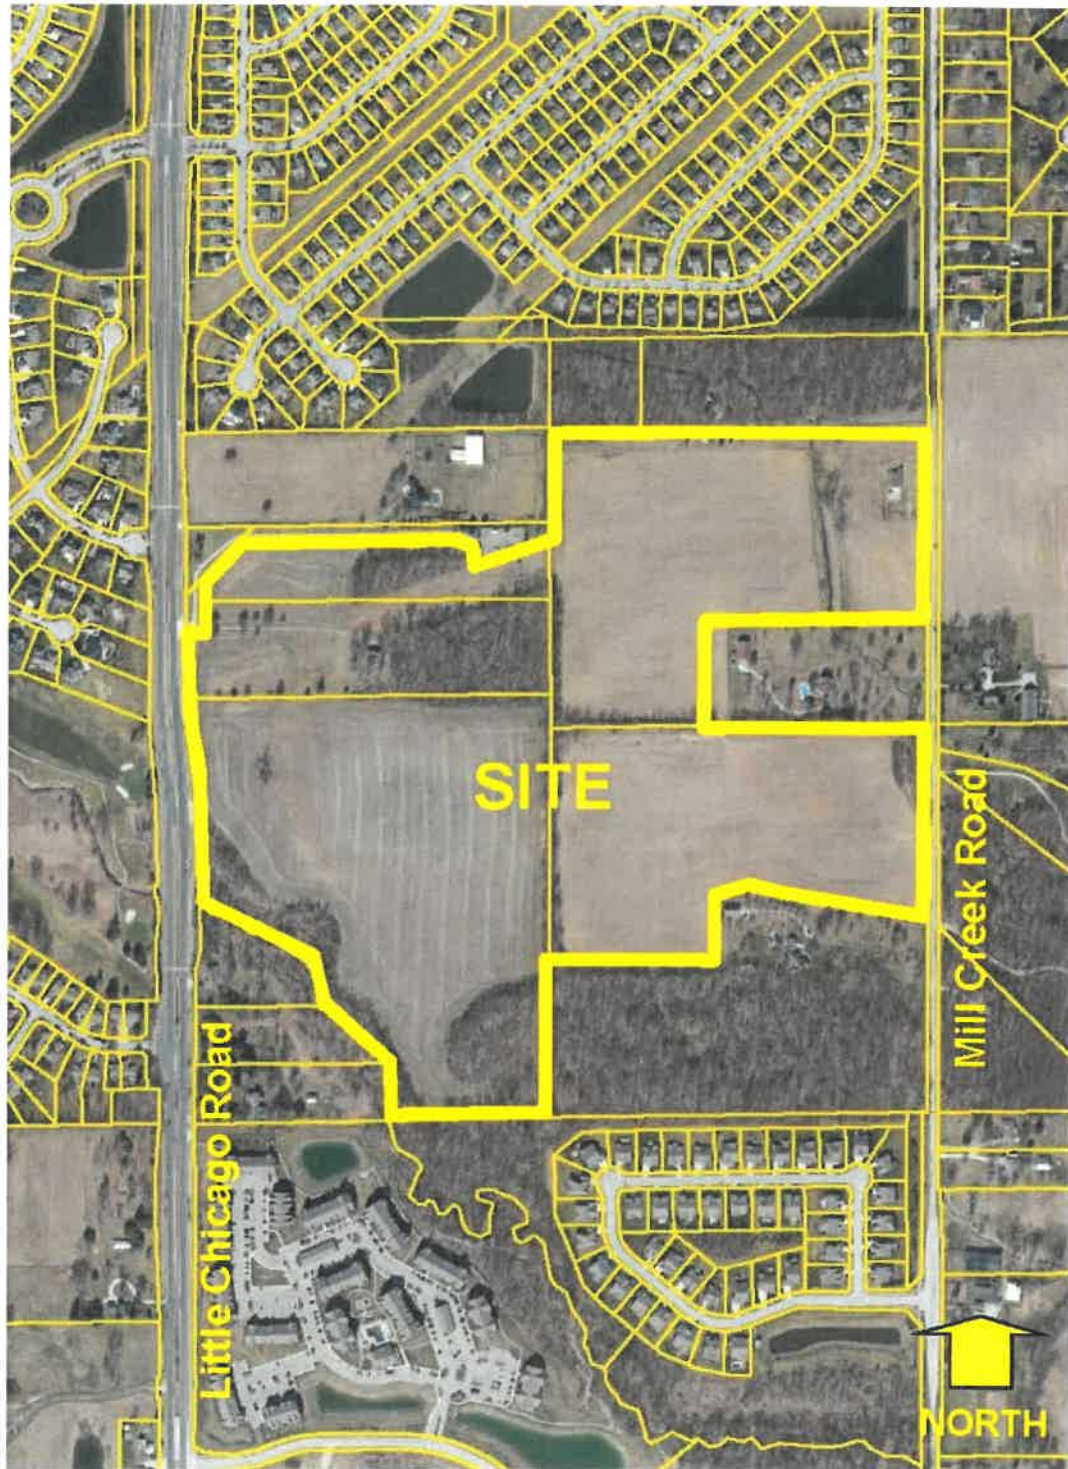


EXHIBIT B

PRELIMINARY DEVELOPMENT PLAN

Mont Claire

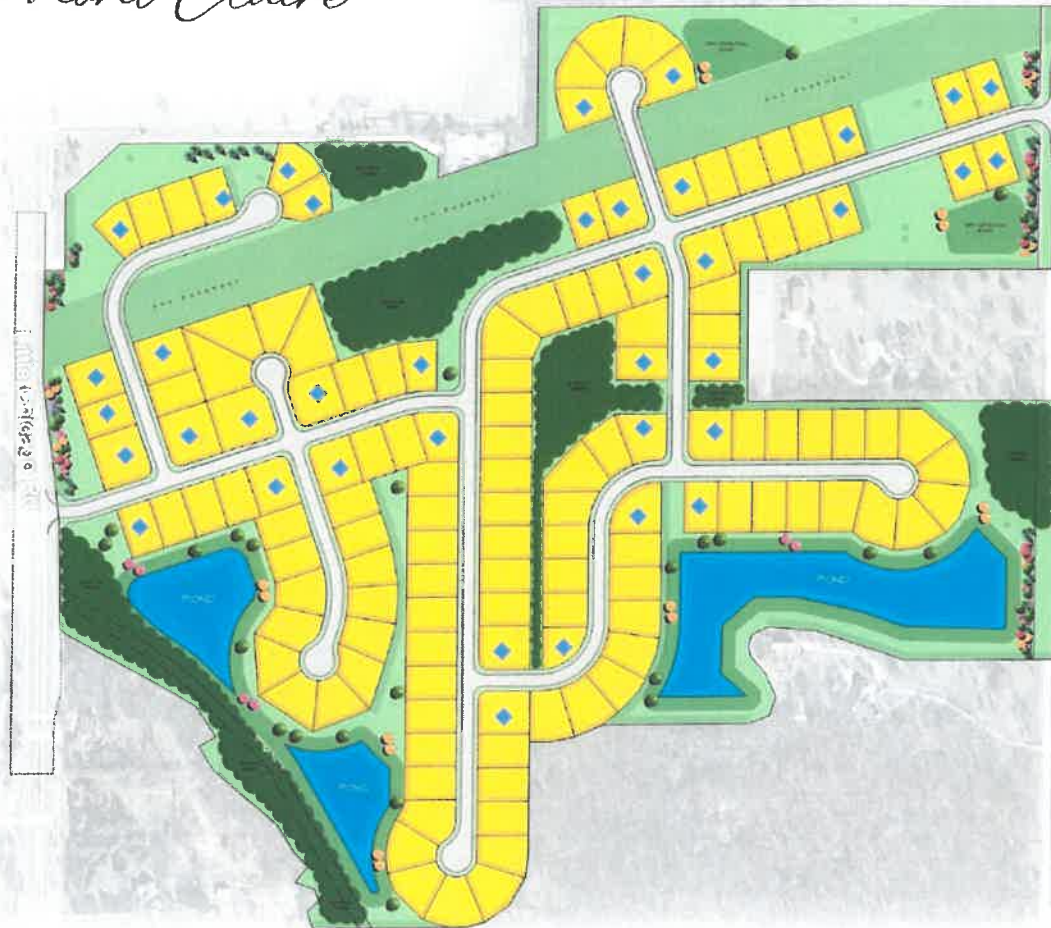

(See following 27 pages which is the PDP plan set on file with Noblesville Planning)

UTILITY AND GOVERNING AGENCIES CONTACTS				
SERVICE / JURISDICTION	COMPANY / DEPT.	ADDRESS	PHONE NUMBER	CONTACT
GASTRAY RIVER	CITY OF MOBILE/AFLE WATERWORKS	101 WEST NORTHERN STREET MOBILE, AL 36680	317-776-8533	
WATER	CITIZENS ENERGY GULFPOWER	5125 N. NORTHERN AVE. AND RR. ST. LOUISVILLE, AL 36680	317-927-4351	
STREETS	CITY OF MOBILE/AFLE DEPARTMENT OF PUBLIC WORKS	15 SOUTH 10TH STREET, SUITE 100 MOBILE, AL 36680	317-776-6339	
SEWAGE	MOBILE SANITARY DEPARTMENT OF ENGINEERING	14 SOUTH 10TH STREET, SUITE 100 MOBILE, AL 36680	317-776-6330	
ELECTRICITY	DUKE ENERGY INDIANA	10 SOUTH HILL CHERRY ROAD MOBILE, AL 36680	317-776-5555	MARK DILLER
NATURAL GAS	VECTREN ENERGY	1000 ALA. HIGHWAY 160 ROAD MOBILE, AL 36680	317-776-6537	CATY WESBEN
TO REMOVE CONCRETE/PAVING	ATT. - ENGINEERING	FLOOR, ROOM 300 MOBILE/AFLES, AL 36680	317-932-4267	BRYAN PETERS
FLEET OFFICES	MOBILE USA	640 G. STREET SW/ P.O. BOX 3177 CENTR MOBILE, AL 36680	317-697-2363	

Sheet List Table

Sheet Number	Sheet Title
C100	DOOR SEFT
C01	EXTERIOR DOOR TRIM
P100	RELAXED PLAT
P01	RELAXED PLAT
P102	RELAXED PLAT
P103	RELAXED PLAT
P104	RELAXED PLAT
C010	SIT DEVELOPMENT PLAN
C011	RELAXED PLAT
C012	SIT DEVELOPMENT PLAN
C013	SIT DEVELOPMENT PLAN
C014	SIT DEVELOPMENT PLAN
C015	SHORE AND LANDING
C016	SHORE AND LANDING
C017	SHORE AND LANDING
C018	SHORE AND LANDING
C019	SHORE AND LANDING
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C095	SHORE AND LANDING
C096	SHORE AND LANDING
C097	SHORE AND LANDING
C098	SHORE AND LANDING
C099	SHORE AND LANDING
C100	SHORE AND LANDING

Street Name	Address Range	Area	Population
1st St	100-199	100	100
2nd St	200-299	200	200
3rd St	300-399	300	300
4th St	400-499	400	400
5th St	500-599	500	500
6th St	600-699	600	600
7th St	700-799	700	700
8th St	800-899	800	800
9th St	900-999	900	900
10th St	1000-1099	1000	1000
11th St	1100-1199	1100	1100
12th St	1200-1299	1200	1200
13th St	1300-1399	1300	1300
14th St	1400-1499	1400	1400
15th St	1500-1599	1500	1500
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18th St	1800-1899	1800	1800
19th St	1900-1999	1900	1900
20th St	2000-2099	2000	2000
21st St	2100-2199	2100	2100
22nd St	2200-2299	2200	2200
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25th St	2500-2599	2500	2500
26th St	2600-2699	2600	2600
27th St	2700-2799	2700	2700
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30th St	3000-3099	3000	3000
31st St	3100-3199	3100	3100
32nd St	3200-3299	3200	3200
33rd St	3300-3399	3300	3300
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36th St	3600-3699	3600	3600
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39th St	3900-3999	3900	3900
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48th St	4800-4899	4800	4800
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53rd St	5300-5399	5300	5300
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60th St	6000-6099	6000	6000
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62nd St	6200-6299	6200	6200
63rd St	6300-6399	6300	6300
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65th St	6500-6599	6500	6500
66th St	6600-6699	6600	6600
67th St	6700-6799	6700	6700
68th St	6800-6899	6800	6800
69th St	6900-6999	6900	6900
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71st St	7100-7199	7100	7100
72nd St	7200-7299	7200	7200
73rd St	7300-7399	7300	7300
74th St	7400-7499	7400	7400
75th St	7500-7599	7500	7500
76th St	7600-7699	7600	7600
77th St	7700-7799	7700	7700
78th St	7800-7899	7800	7800
79th St	7900-7999	7900	7900
80th St	8000-8099	8000	8000
81st St	8100-8199	8100	8100
82nd St	8200-8299	8200	8200
83rd St	8300-8399	8300	8300
84th St	8400-8499	8400	8400
85th St	8500-8599	8500	8500
86th St	8600-8699	8600	8600
87th St	8700-8799	8700	8700
88th St	8800-8899	8800	8800
89th St	8900-8999	8900	8900
90th St	9000-9099	9000	9000
91st St	9100-9199	9100	9100
92nd St	9200-9299	9200	9200
93rd St	9300-9399	9300	9300
94th St	9400-9499	9400	9400
95th St	9500-9599	9500	9500
96th St	9600-9699	9600	9600
97th St	9700-9799	9700	9700
98th St	9800-9899	9800	9800
99th St	9900-9999	9900	9900
100th St	10000-10099	10000	10000



Street Name	Address Range	Area	Population
1st St	100-199	100	100
2nd St	200-299	200	200
3rd St	300-399	300	300
4th St	400-499	400	400
5th St	500-599	500	500
6th St	600-699	600	600
7th St	700-799	700	700
8th St	800-899	800	800
9th St	900-999	900	900
10th St	1000-1099	1000	1000
11th St	1100-1199	1100	1100
12th St	1200-1299	1200	1200
13th St	1300-1399	1300	1300
14th St	1400-1499	1400	1400
15th St	1500-1599	1500	1500
16th St	1600-1699	1600	1600
17th St	1700-1799	1700	1700
18th St	1800-1899	1800	1800
19th St	1900-1999	1900	1900
20th St	2000-2099	2000	2000
21st St	2100-2199	2100	2100
22nd St	2200-2299	2200	2200
23rd St	2300-2399	2300	2300
24th St	2400-2499	2400	2400
25th St	2500-2599	2500	2500
26th St	2600-2699	2600	2600
27th St	2700-2799	2700	2700
28th St	2800-2899	2800	2800
29th St	2900-2999	2900	2900
30th St	3000-3099	3000	3000
31st St	3100-3199	3100	3100
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33rd St	3300-3399	3300	3300
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35th St	3500-3599	3500	3500
36th St	3600-3699	3600	3600
37th St	3700-3799	3700	3700
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39th St	3900-3999	3900	3900
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45th St	4500-4599	4500	4500
46th St	4600-4699	4600	4600
47th St	4700-4799	4700	4700
48th St	4800-4899	4800	4800
49th St	4900-4999	4900	4900
50th St	5000-5099	5000	5000
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52nd St	5200-5299	5200	5200
53rd St	5300-5399	5300	5300
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55th St	5500-5599	5500	5500
56th St	5600-5699	5600	5600
57th St	5700-5799	5700	5700
58th St	5800-5899	5800	5800
59th St	5900-5999	5900	5900
60th St	6000-6099	6000	6000
61st St	6100-6199	6100	6100
62nd St	6200-6299	6200	6200
63rd St	6300-6399	6300	6300
64th St	6400-6499	6400	6400
65th St	6500-6599	6500	6500
66th St	6600-6699	6600	6600
67th St	6700-6799	6700	6700
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75th St	7500-7599	7500	7500
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79th St	7900-7999	7900	7900
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81st St	8100-8199	8100	8100
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83rd St	8300-8399	8300	8300
84th St	8400-8499	8400	8400
85th St	8500-8599	8500	8500
86th St	8600-8699	8600	8600
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88th St	8800-8899	8800	8800
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93rd St	9300-9399	9300	9300
94th St	9400-9499	9400	9400
95th St	9500-9599	9500	9500
96th St	9600-9699	9600	9600
97th St	9700-9799	9700	9700
98th St	9800-9899	9800	9800
99th St	9900-9999	9900	9900
100th St	10000-10099	10000	10000

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6th St	600-699	600	600
7th St	700-799	700	700
8th St	800-899	800	800
9th St	900-999	900	900
10th St	1000-1099	1000	1000
11th St	1100-1199	1100	1100
12th St	1200-1299	1200	1200
13th St	1300-1399	1300	1300
14th St	1400-1499	1400	1400
15th St	1500-1599	1500	1500
16th St	1600-1699	1600	1600
17th St	1700-1799	1700	1700
18th St	1800-1899	1800	1800
19th St	1900-1999	1900	1900
20th St	2000-2099	2000	2000
21st St	2100-2199	2100	2100
22nd St	2200-2299	2200	2200
23rd St	2300-2399	2300	2300
24th St	2400-2499	2400	2400
25th St	2500-2599	2500	2500
26th St	2600-2699	2600	2600
27th St	2700-2799	2700	2700
28th St	2800-2899	2800	2800
29th St	2900-2999	2900	2900
30th St	3000-3099	3000	3000
31st St	3100-3199	3100	3100
32nd St	3200-3299	3200	3200
33rd St	3300-3399	3300	3300
34th St	3400-3499	3400	3400
35th St	3500-3599	3500	3500
36th St	3600-3699	3600	3600
37th St	3700-3799	3700	3700
38th St	3800-3899	3800	3800
39th St	3900-3999	3900	3900
40th St	4000-4099	4000	4000
41st St	4100-4199	4100	4100
42nd St	4200-4299	4200	4200
43rd St	4300-4399	4300	4300
44th St	4400-4499	4400	4400
45th St	4500-4599	4500	4500
46th St	4600-4699	4600	4600
47th St	4700-4799	4700	4700
48th St	4800-4899	4800	4800
49th St	4900-4999	4900	4900
50th St	5000-5099	5000	5000
51st St	5100-5199	5100	5100
52nd St	5200-5299	5200	5200
53rd St	5300-5399	5300	5300
54th St	5400-5499	5400	5400
55th St	5500-5599	5500	5500
56th St	5600-5699	5600	5600
57th St	5700-5799	5700	5700
58th St	5800-5899	5800	5800
59th St	5900-5999	5900	5900
60th St	6000-6099	6000	6000
61st St	6100-6199	6100	6100
62nd St	6200-6299	6200	6200
63rd St	6300-6399	6300	6300
64th St	6400-6499	6400	6400
65th St	6500-6599	6500	6500
66th St	6600-6699	6600	6600
67th St	6700-6799	6700	6700
68th St	6800-6899	6800	6800
69th St	6900-6999	6900	6900
70th St	7000-7099	7000	7000
71st St	7100-7199	7100	7100
72nd St	7200-7299	7200	7200
73rd St	7300-7399	7300	7300
74th St	7400-7499	7400	7400
75th St	7500-7599	7500	7500
76th St	7600-7699	7600	

PRESIDENT - MALINDA WILCOX

SECRETARY - STEVEN R. HUNTLEY

LOCATION MAP

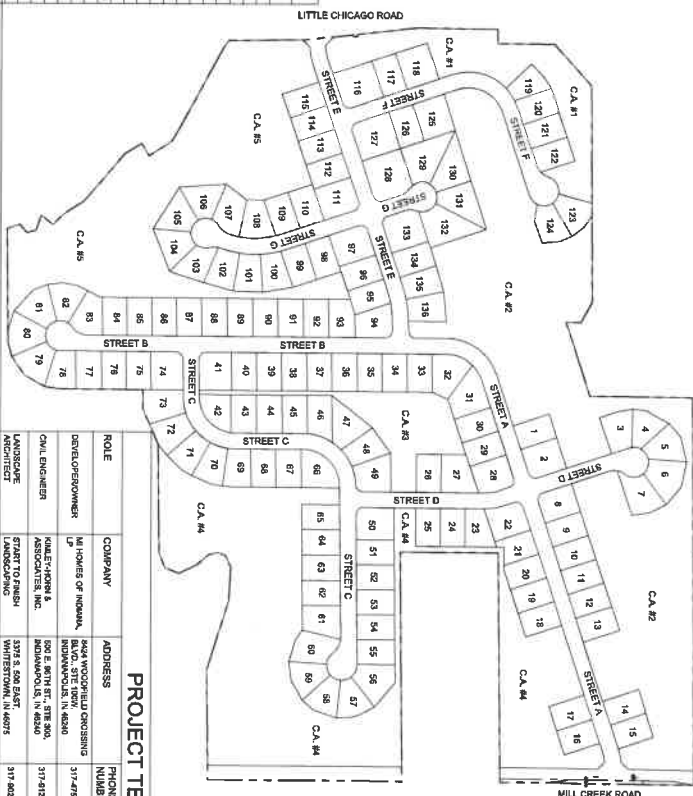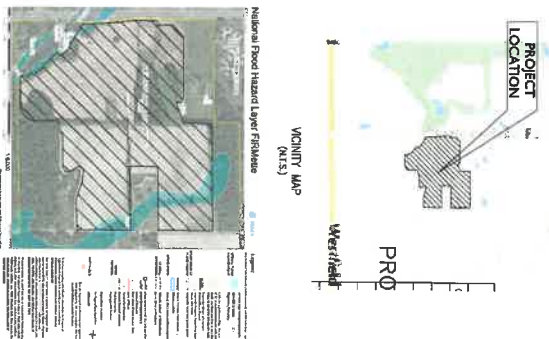[illegible]

PROJECT INFORMATION	
TOTAL AREA	37.36 AC.
TOTAL LOTS	181
TOTAL ACRES	36.66 AC.
DEVELOPED LAND	28.94 AC.
UNDEVELOPED LAND	7.72 AC. (20.80%)
NET DEVELOPMENT	8,227 C.U.
LAND VALUE	\$677.54
NET VALUE	\$661.14
TOTAL ROW	16.46 AC.
ROW AREA	16.46 AC.
ROW VALUE	\$713.93
NET DEVELOPMENT	15.61 AC.
NET DEVELOPMENT	15.61 AC.

Indiana Utilities Protection Service
Call 811
before you dig



SPOT HEIGHTS
SPOT ELEVATIONS
CENTERLINE
RIGHT-OF-WAY
ADJACENT PROPERTY
ADJACENT ROAD
ADJACENT RAILROAD
ADJACENT AIRPORT
ADJACENT WATERWAY
ADJACENT WETLAND
ADJACENT WOODLAND
ADJACENT PRAIRIE
ADJACENT CROPLAND
ADJACENT URBAN
ADJACENT RURAL
ADJACENT FOREST
ADJACENT WETLAND
ADJACENT WOODLAND
ADJACENT PRAIRIE
ADJACENT CROPLAND
ADJACENT URBAN
ADJACENT RURAL
ADJACENT FOREST

LEGEND

SPOT HEIGHTS
SPOT ELEVATIONS
CENTERLINE
RIGHT-OF-WAY
ADJACENT PROPERTY
ADJACENT ROAD
ADJACENT RAILROAD
ADJACENT AIRPORT
ADJACENT WATERWAY
ADJACENT WETLAND
ADJACENT WOODLAND
ADJACENT PRAIRIE
ADJACENT CROPLAND
ADJACENT URBAN
ADJACENT RURAL
ADJACENT FOREST

GRAPHIC SCALE IN FEET
0 100 200



Call 817
Before you dig

IMPROVE UTILITIES PRODUCTION SERVICE

C203

MONTCLAIRE
PRIMARY PLAT

EXISTING
CONDITIONS




APPROVAL PENDING
NOT FOR
CONSTRUCTION

DESIGN: AS NOTED
DRAWN BY: JSM
CHECKED BY: BAH
KIMLEY-HORN & ASSOCIATES, INC.
300 EAST 96TH STREET, SUITE 300
MINNEAPOLIS, MN 55412
CONTACT: BRETT HUFF
PHONE: 312-542-4700
FAX: 312-542-4701
WWW.KIMLEY-HORN.COM

No.	REVISIONS PER TAC COMMENTS	DATE	PCW BY
1	REVISIONS	4/24/25	PCW

MATCHLINE - SEE SHEET P103

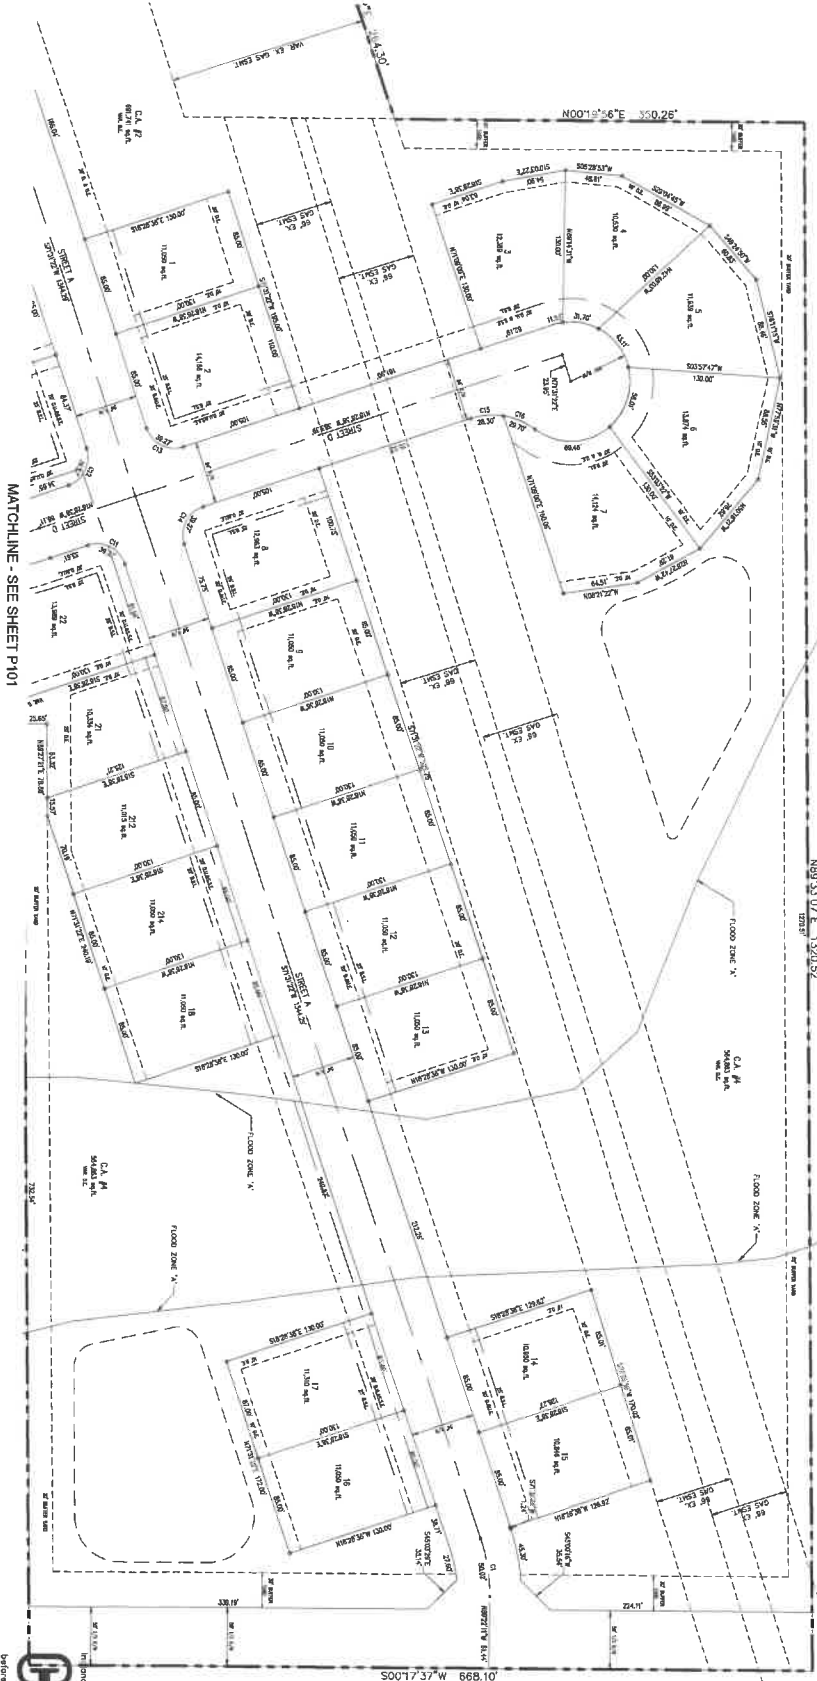


MATCHLINE - SEE SHEET P101

PARCEL CURVE TABLE				
CURVE	RADIUS	LENGTH	CHORD BEARING	CHORD
C1	25.00'	39.27'	N63°28'38\"	35.38'
C2	25.00'	39.27'	N63°28'38\"	35.38'
C3	25.00'	39.27'	N63°28'38\"	35.38'
C4	25.00'	39.27'	N63°28'38\"	35.38'
C5	25.00'	39.27'	N63°28'38\"	35.38'
C6	25.00'	39.27'	N63°28'38\"	35.38'
C7	25.00'	39.27'	N63°28'38\"	35.38'
C8	25.00'	39.27'	N63°28'38\"	35.38'
C9	25.00'	39.27'	N63°28'38\"	35.38'
C10	25.00'	39.27'	N63°28'38\"	35.38'
C11	25.00'	39.27'	N63°28'38\"	35.38'
C12	25.00'	39.27'	N63°28'38\"	35.38'
C13	25.00'	39.27'	N63°28'38\"	35.38'
C14	25.00'	39.27'	N63°28'38\"	35.38'
C15	25.00'	39.27'	N63°28'38\"	35.38'
C16	25.00'	39.27'	N63°28'38\"	35.38'
C17	25.00'	39.27'	N63°28'38\"	35.38'
C18	25.00'	39.27'	N63°28'38\"	35.38'
C19	25.00'	39.27'	N63°28'38\"	35.38'
C20	25.00'	39.27'	N63°28'38\"	35.38'
C21	25.00'	39.27'	N63°28'38\"	35.38'
C22	25.00'	39.27'	N63°28'38\"	35.38'
C23	25.00'	39.27'	N63°28'38\"	35.38'
C24	25.00'	39.27'	N63°28'38\"	35.38'
C25	25.00'	39.27'	N63°28'38\"	35.38'
C26	25.00'	39.27'	N63°28'38\"	35.38'
C27	25.00'	39.27'	N63°28'38\"	35.38'
C28	25.00'	39.27'	N63°28'38\"	35.38'
C29	25.00'	39.27'	N63°28'38\"	35.38'
C30	25.00'	39.27'	N63°28'38\"	35.38'
C31	25.00'	39.27'	N63°28'38\"	35.38'
C32	25.00'	39.27'	N63°28'38\"	35.38'
C33	25.00'	39.27'	N63°28'38\"	35.38'


PARCEL CURVE TABLE				
CURVE	RADIUS	LENGTH	CHORD BEARING	CHORD
C34	25.00'	39.27'	N63°28'38\"	35.38'
C35	25.00'	39.27'	N63°28'38\"	35.38'
C36	25.00'	39.27'	N63°28'38\"	35.38'
C100	25.00'	39.27'	N63°28'38\"	35.38'

STREET CENTRILINE CURVE TABLE				
CURVE	RADIUS	LENGTH	CHORD BEARING	CHORD
C1	150.00'	50.00'	S89°15'55\"	49.09'
C2	150.00'	50.00'	S89°15'55\"	49.09'
C3	150.00'	50.00'	S89°15'55\"	49.09'
C4	150.00'	50.00'	S89°15'55\"	49.09'
C5	150.00'	50.00'	S89°15'55\"	49.09'
C6	150.00'	50.00'	S89°15'55\"	49.09'
C7	150.00'	50.00'	S89°15'55\"	49.09'
C8	150.00'	50.00'	S89°15'55\"	49.09'
C9	150.00'	50.00'	S89°15'55\"	49.09'
C10	150.00'	50.00'	S89°15'55\"	49.09'
C11	150.00'	50.00'	S89°15'55\"	49.09'
C12	150.00'	50.00'	S89°15'55\"	49.09'
C13	150.00'	50.00'	S89°15'55\"	49.09'
C14	150.00'	50.00'	S89°15'55\"	49.09'
C15	150.00'	50.00'	S89°15'55\"	49.09'
C16	150.00'	50.00'	S89°15'55\"	49.09'
C17	150.00'	50.00'	S89°15'55\"	49.09'
C18	150.00'	50.00'	S89°15'55\"	49.09'
C19	150.00'	50.00'	S89°15'55\"	49.09'
C20	150.00'	50.00'	S89°15'55\"	49.09'
C21	150.00'	50.00'	S89°15'55\"	49.09'
C22	150.00'	50.00'	S89°15'55\"	49.09'
C23	150.00'	50.00'	S89°15'55\"	49.09'
C24	150.00'	50.00'	S89°15'55\"	49.09'
C25	150.00'	50.00'	S89°15'55\"	49.09'
C26	150.00'	50.00'	S89°15'55\"	49.09'
C27	150.00'	50.00'	S89°15'55\"	49.09'
C28	150.00'	50.00'	S89°15'55\"	49.09'
C29	150.00'	50.00'	S89°15'55\"	49.09'
C30	150.00'	50.00'	S89°15'55\"	49.09'
C31	150.00'	50.00'	S89°15'55\"	49.09'
C32	150.00'	50.00'	S89°15'55\"	49.09'
C33	150.00'	50.00'	S89°15'55\"	49.09'
C34	150.00'	50.00'	S89°15'55\"	49.09'
C35	150.00'	50.00'	S89°15'55\"	49.09'
C36	150.00'	50.00'	S89°15'55\"	49.09'
C37	150.00'	50.00'	S89°15'55\"	49.09'
C38	150.00'	50.00'	S89°15'55\"	49.09'
C39	150.00'	50.00'	S89°15'55\"	49.09'
C40	150.00'	50.00'	S89°15'55\"	49.09'
C41	150.00'	50.00'	S89°15'55\"	49.09'
C42	150.00'	50.00'	S89°15'55\"	49.09'
C43	150.00'	50.00'	S89°15'55\"	49.09'
C44	150.00'	50.00'	S89°15'55\"	49.09'
C45	150.00'	50.00'	S89°15'55\"	49.09'
C46	150.00'	50.00'	S89°15'55\"	49.09'
C47	150.00'	50.00'	S89°15'55\"	49.09'
C48	150.00'	50.00'	S89°15'55\"	49.09'
C49	150.00'	50.00'	S89°15'55\"	49.09'
C50	150.00'	50.00'	S89°15'55\"	49.09'


- LEGEND
- 1. LOT NUMBER
 - 2. EASEMENT
 - 3. EASEMENT
 - 4. EASEMENT
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 - 97. EASEMENT
 - 98. EASEMENT
 - 99. EASEMENT
 - 100. EASEMENT

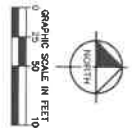



Call 811

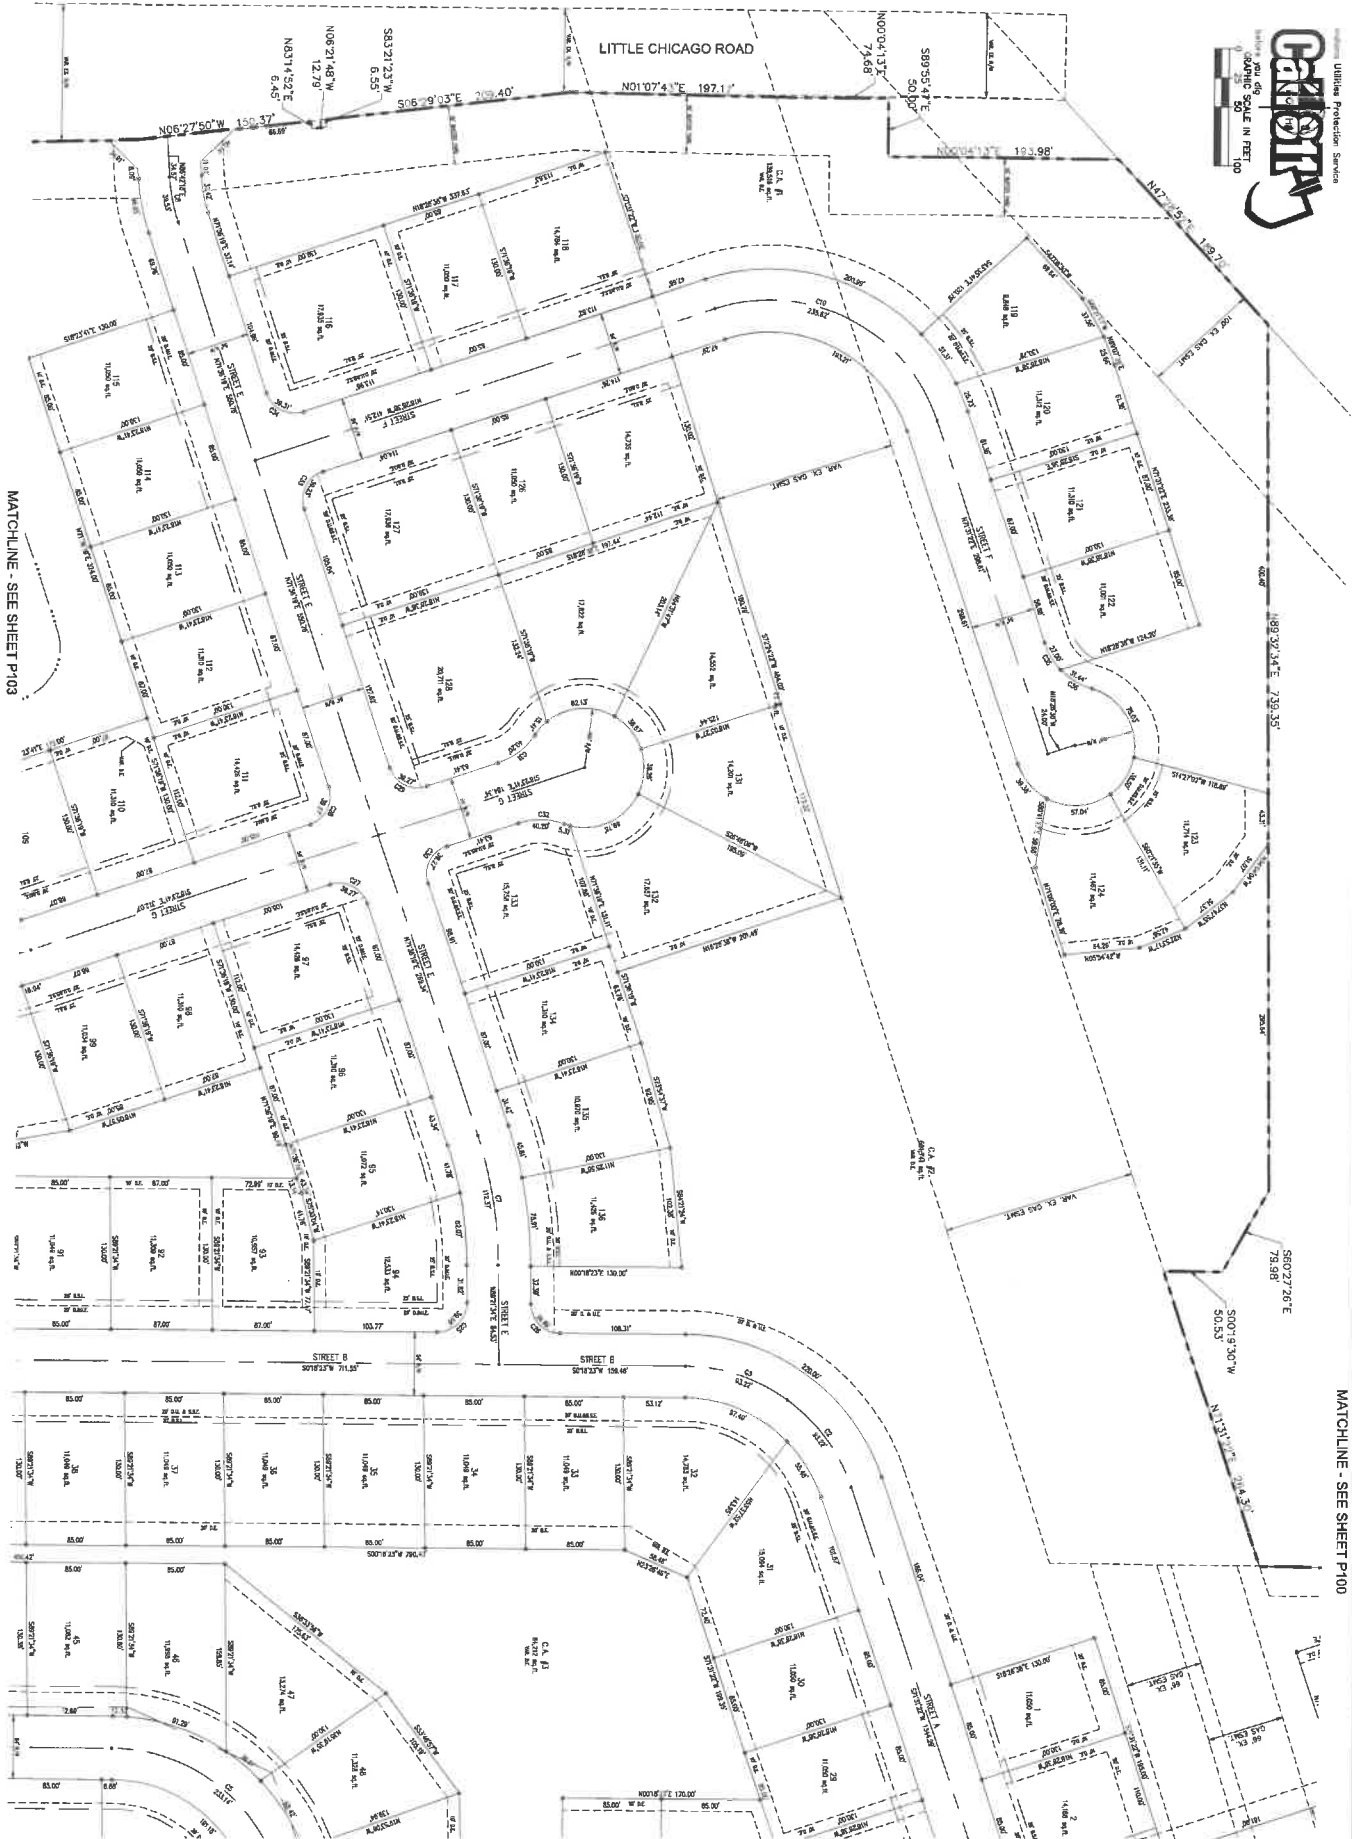

P101	ORIGINAL ISSUE: KHA PROJECT NO. 17050003 SHEET NUMBER	MONTCLAIR PRIMARY PLAT	PRIMARY PLAT	 M/I HOMES	APPROVAL PENDING NOT FOR CONSTRUCTION	SCALE: AS NOTED	DESIGNED BY: JSM	DRAWN BY: GMS	CHECKED BY: BAH	Kimley-Horn 300 EAST BETH STREET, SUITE 200, MONTCLAIR, NJ 07042 CONTACT: BRIETT HUFF PHONE: 973-323-1100 FAX: 973-323-1101 WWW.KIMLEY-HORN.COM	1	REVISIONS PER TAC COMMENTS	4/24/25	PCW
						No.					REVISIONS	DATE	BY	

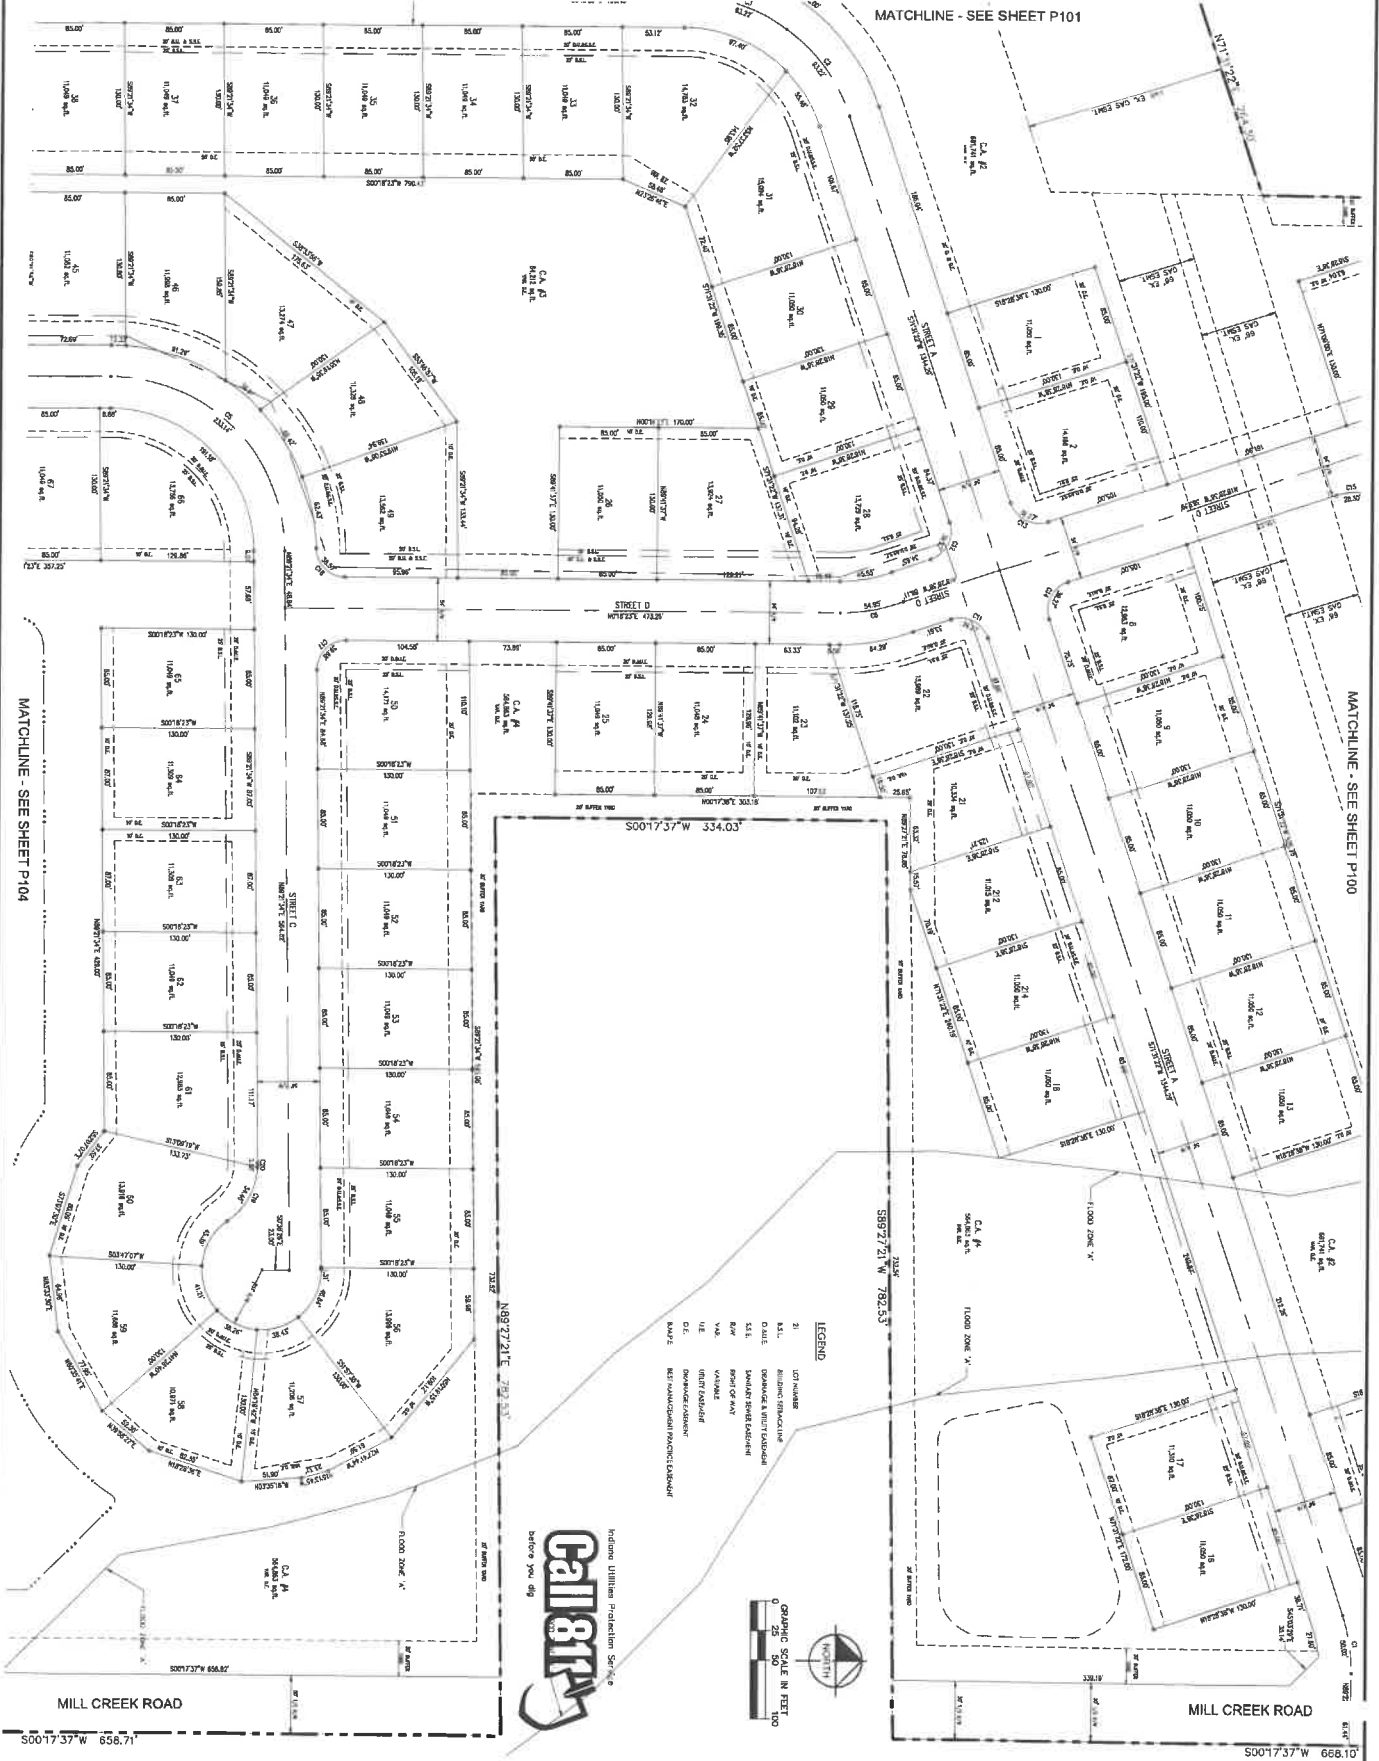

Indicate Utility Protection Symbol

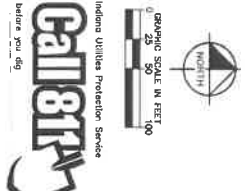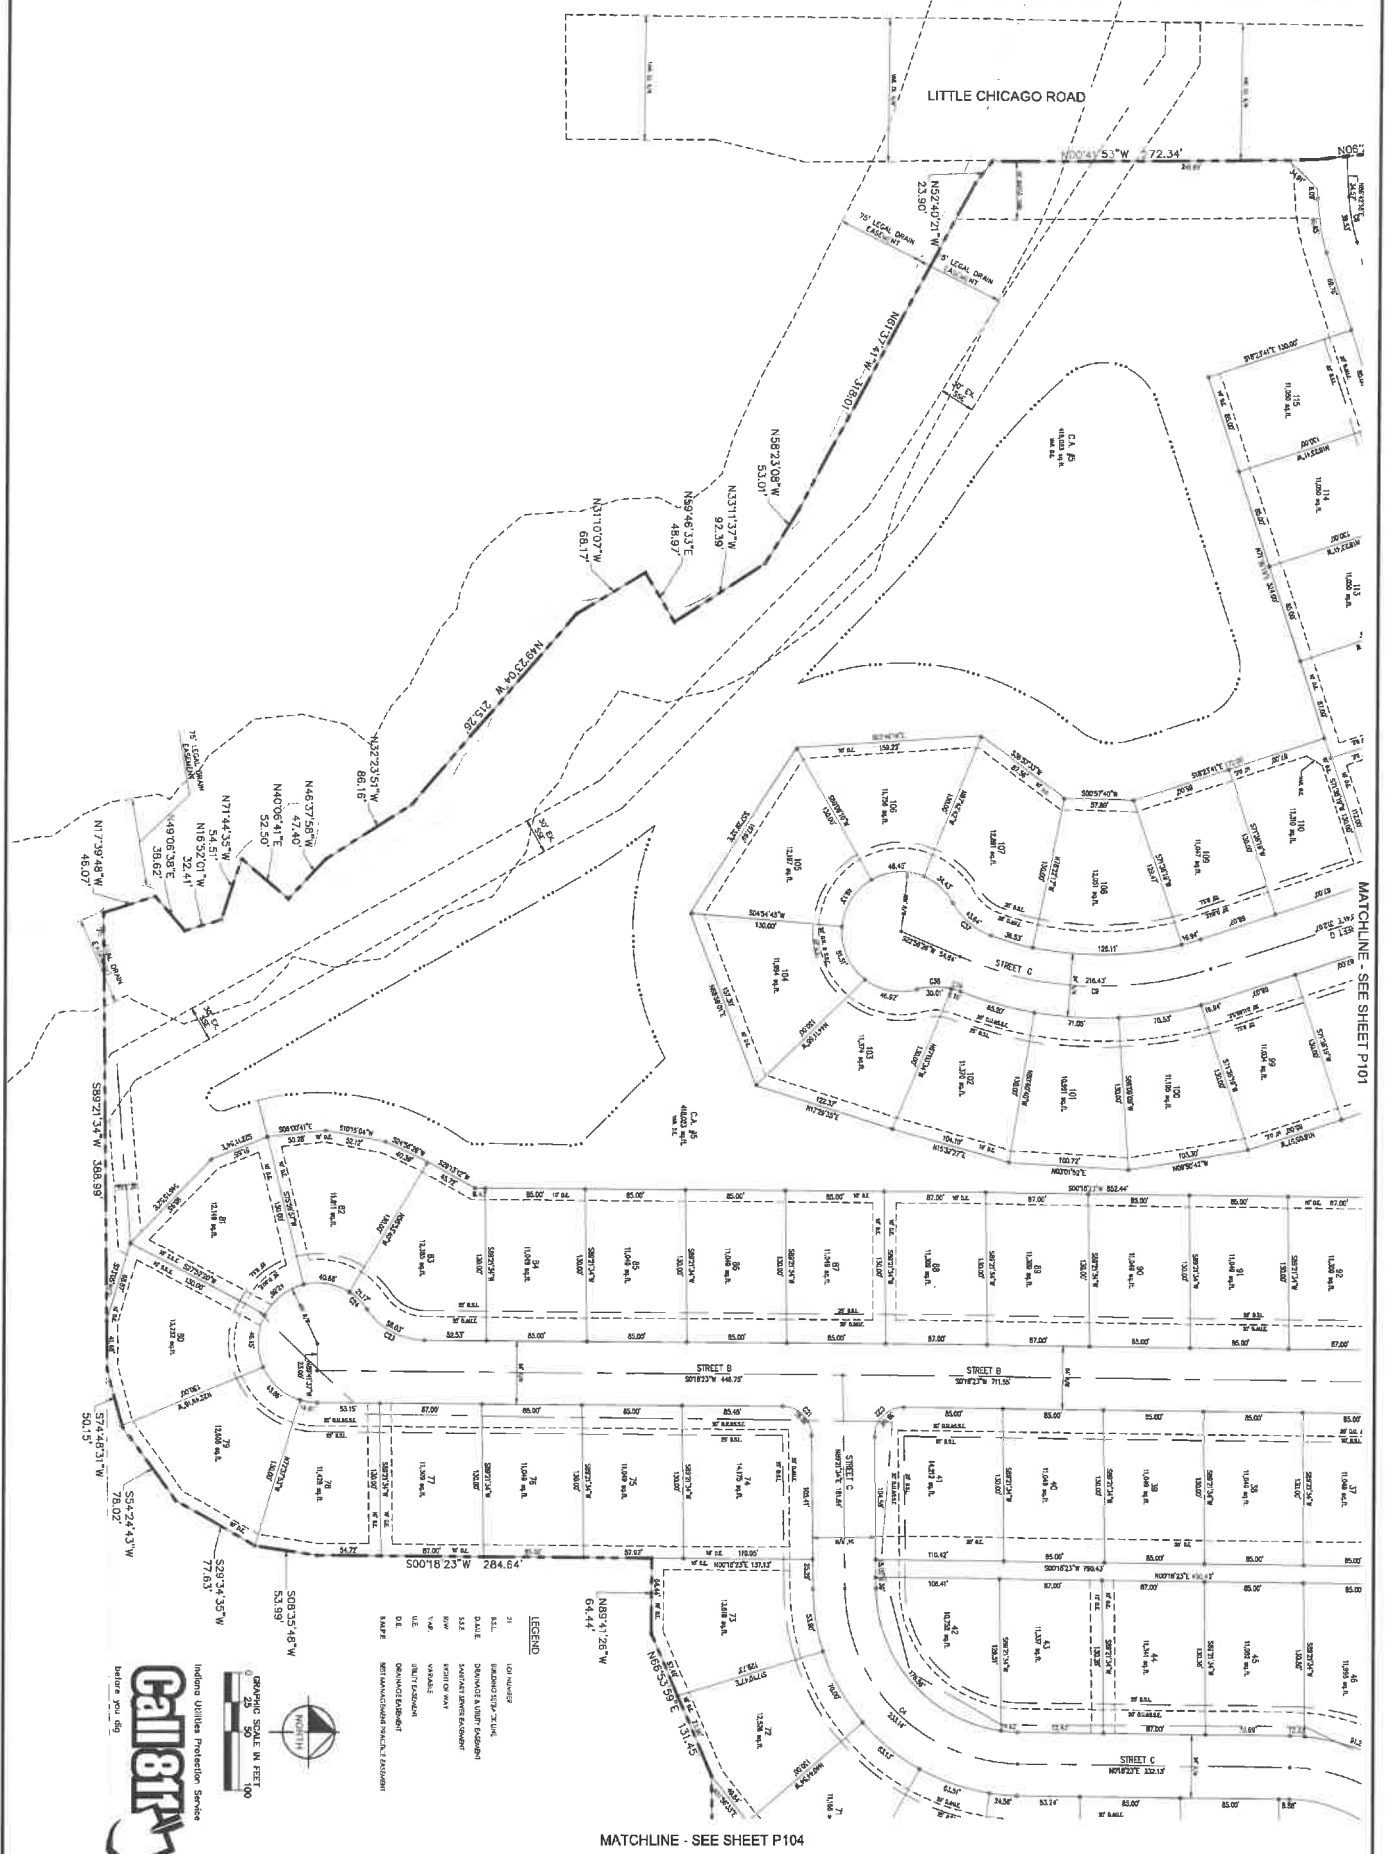


Cal8tr

Imaging Utilities Inspection Service

Before you dig

MATCHLINE - SEE SHEET P104

P103	ORIGINAL ISSUE: 4/24/2025 RHA PROJECT NO. SHEET NUMBER	MONTCLAIRE PRIMARY PLAT	PRIMARY PLAT	 M/I HOMES	APPROVAL PENDING FOR CONSTRUCTION	SCALE: AS NOTED							
						DESIGNED BY: JSM							
						DRAWN BY: QMS							
						CHECKED BY: BAH	3034 KIMLEY-HORN AND ASSOCIATES, INC. 500 EAST BETH STREET, SUITE 200, HOUSTON, TEXAS 77002 CONTACT: BRETT HUFF PHONE: 281-414-1144 FAX: 281-414-1145 WWW.KIMLEY-HORN.COM						
								NO. REVISIONS PER TAC COMMENTS				4/24/25	PCW
								DATE					BY

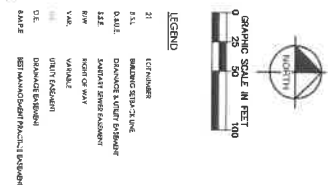

MATCHLINE - SEE SHEET P102

MILL CREEK ROAD

500°17'37"W 658.71'

[illegible]

Indiana Utilities Protection Service
Call 811
before you dig

P104

MONTCLAIRE
PRIMARY PLAT

PRIMARY PLAT



APPROVAL PENDING
NOT FOR
CONSTRUCTION

SCALE:	AS NOTED
DESIGNED BY:	JSM
DRAWN BY:	GMS
CHECKED BY:	BAH

Kimley»Horn

10204 KIMLEY-HORN AND ASSOCIATES, INC.
 300 EAST 95TH STREET, SUITE 300
 INDIANAPOLIS, IN 46240
 CONTACT: BRETT HUFF
 PHONE: 317-812-4129

1	REVISIONS PER TAC COMMENTS	4/24/25	PCW	
No.	REVISIONS	DATE	BY	

N0019'56"E 350.26'



before you dig

Call 811 before you dig

C200

**MONTCLAIRE
PRIMARY PLAT**

SITE DEVELOPMENT PLAN




APPROVAL PENDING
NOT FOR
CONSTRUCTION

CHECKED BY: U

PHONE: 317-912-4120
EMAIL: Brad.Huffman@mcn.com

1	REVISIONS PER TAC COMMENTS	4/24/25	PCW
No.	REVISIONS	DATE	BY

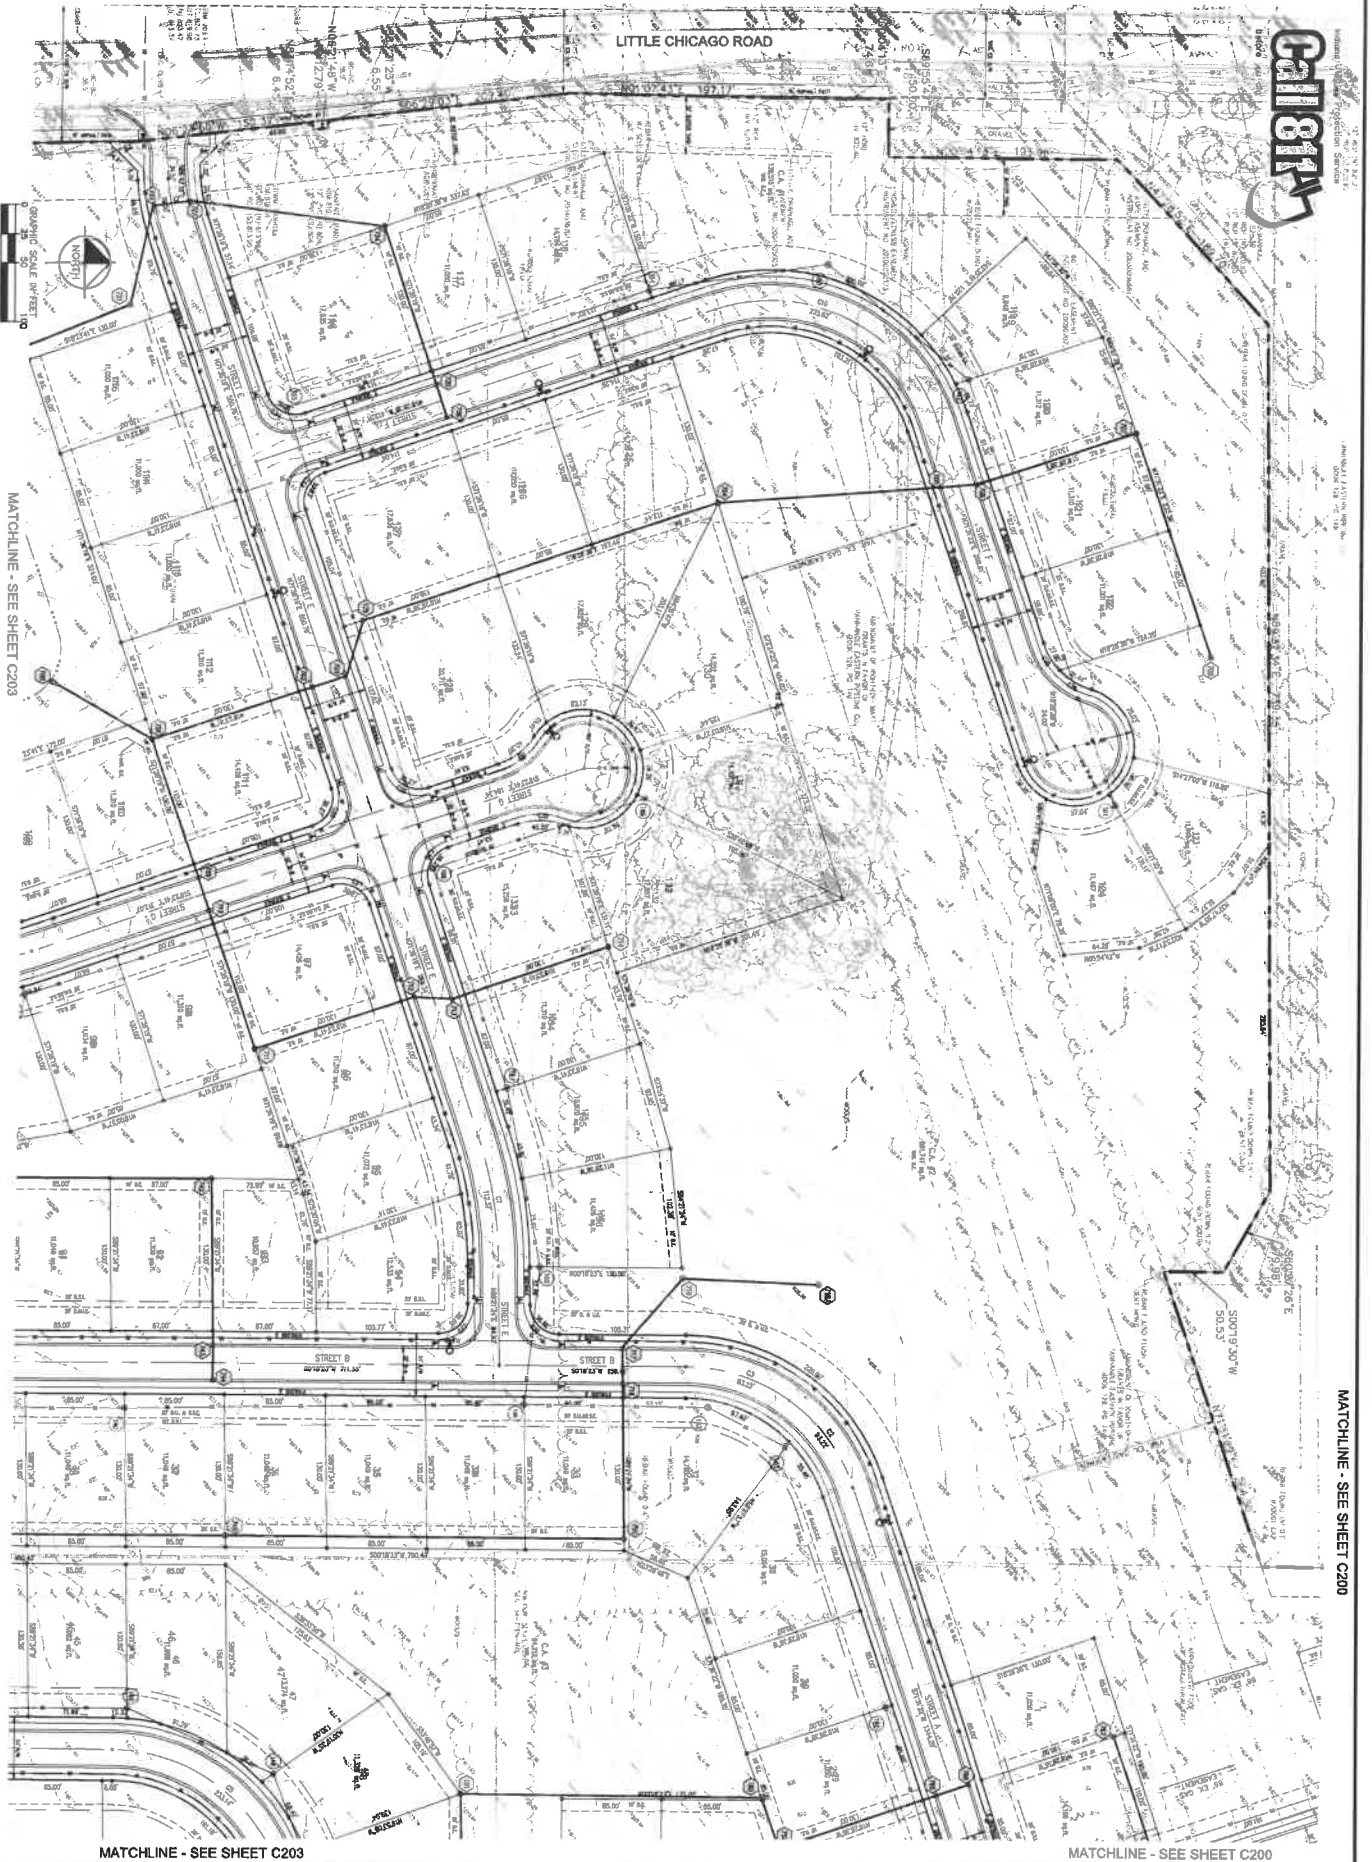

C201

SHEET NUMBER

ORIGINAL ISSUE

KHA PROJECT NO.

170150004

MONTCLAIRE
PRIMARY PLAT

SITE
DEVELOPMENT
PLAN



APPROVAL RECORD
NOT FOR
CONSTRUCTION


AS NOTED
DESIGNED BY: JWM
DRAWN BY: GMS
CHECKED BY: BAH

Kimley-Horn
10101 KIMLEY-HORN ROAD, SUITE 100
500 EAST WIRTH STREET, SUITE 300
CHANDLER, AZ 85226
PH: 480-841-1000
FAX: 480-841-1001
WWW.KIMLEY-HORN.COM

REVISIONS PER TAC COMMENTS	DATE	PCW BY
1	4/24/25	PCW
No.	REVISIONS	



1	REVISIONS PER TAC COMMENTS	4/24/25	PCW
No	REVISIONS	DATE	BY

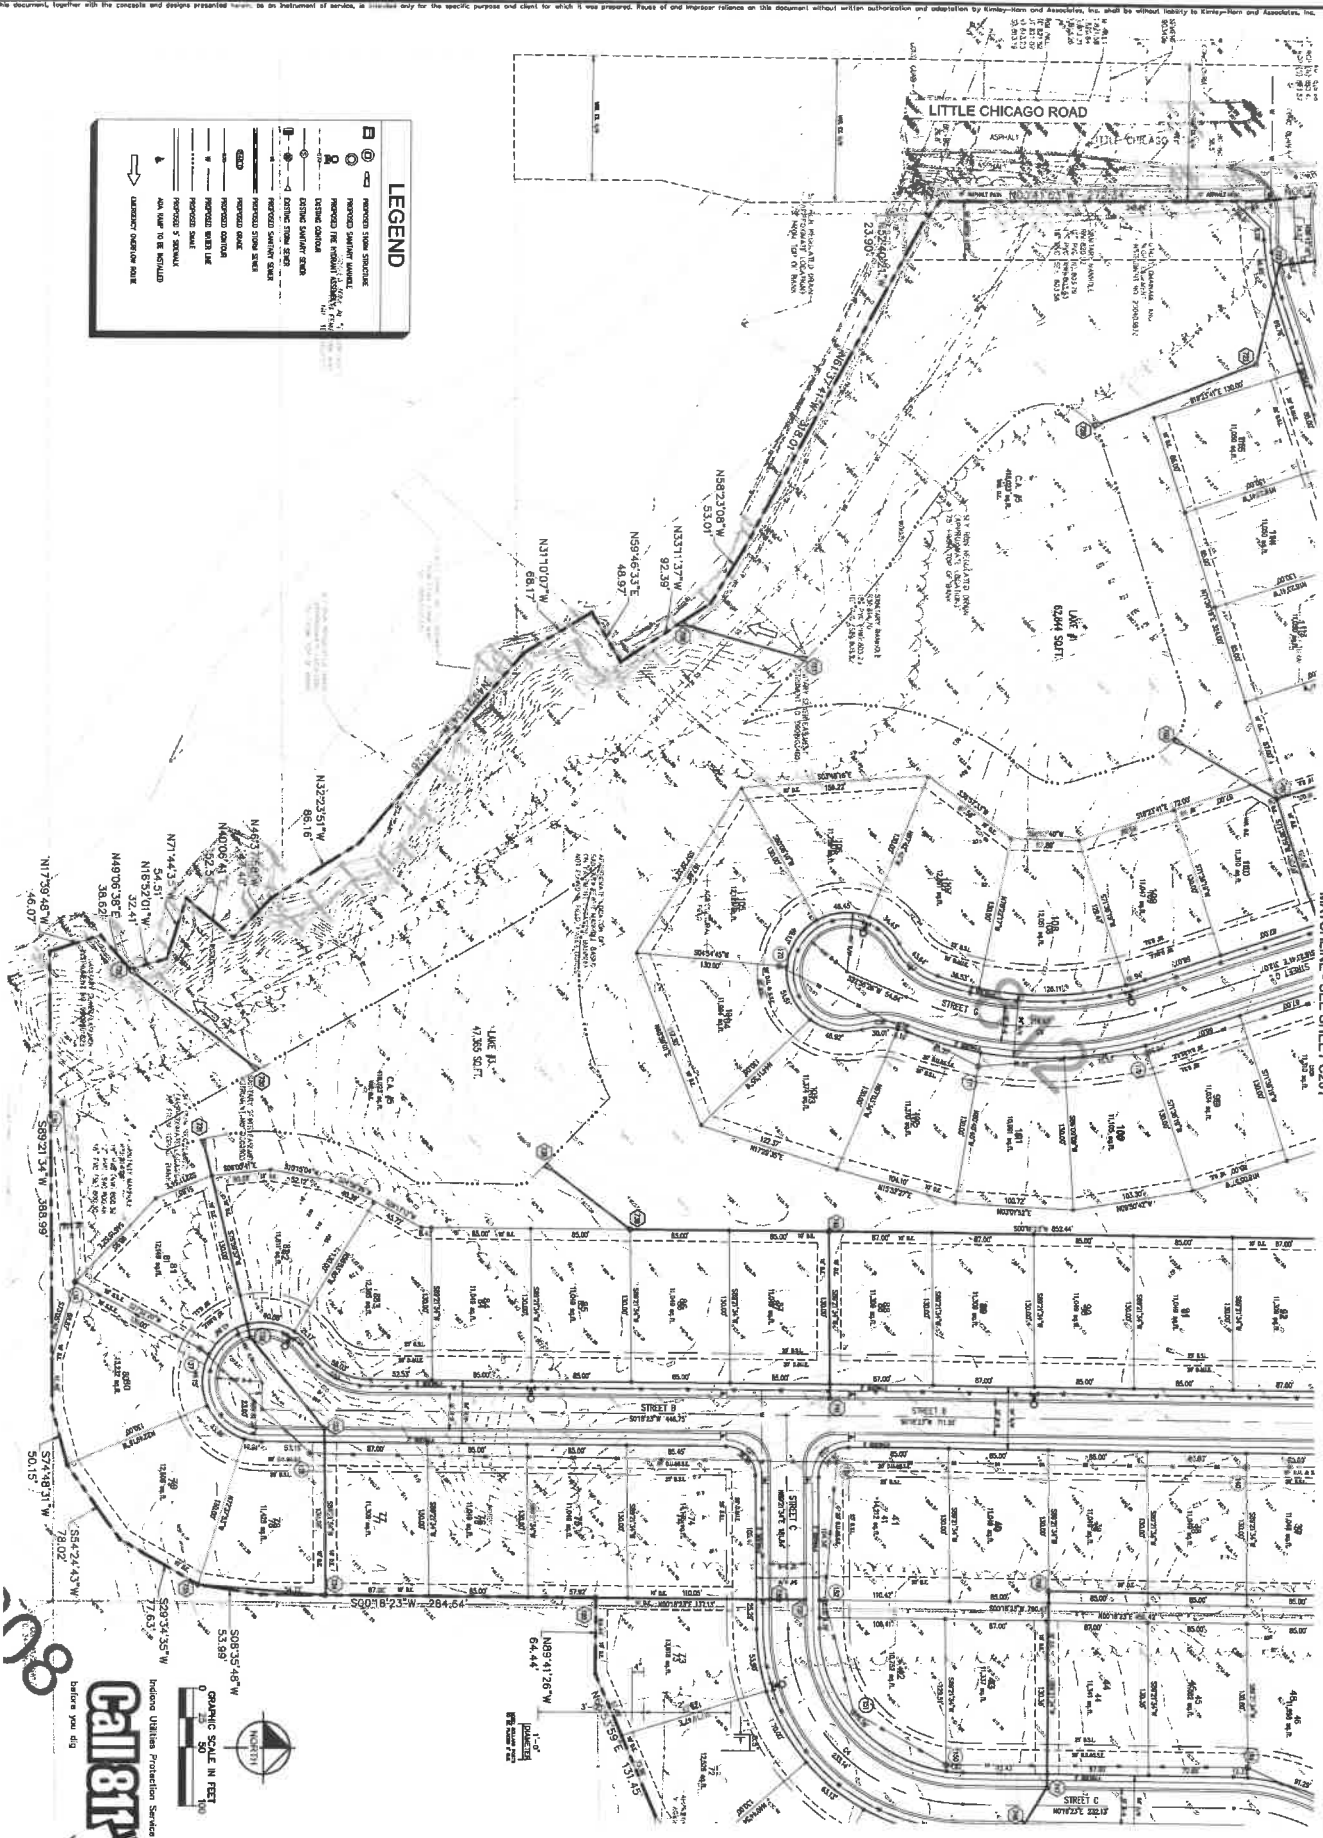

MATCHLINE - SEE SHEET C20

MATCHLINE - SEE SHEET C204

Call 811
before you dig

MONTCLAIRE
PRIMARY PLAT

SITE DEVELOPMENT PLAN



APPROVAL PENDING
NOT FOR
CONSTRUCTION

RECEIVED:	AS NOTED
DISPATCHED BY:	JSM
ARRIVED BY:	GWS
CHECKED BY:	BAH

Kimley»Horn

6024 KIMLEY-HORN AND ASSOCIATES, INC.
500 EAST 88TH STREET, SUITE 300,
INDIANAPOLIS, IN 46240

CONTACT: BRETT HUNT
PHONE: 317-912-4179
FAX: 317-912-4179

EMAIL: BRETT.HUNT@KIMLEY-HORN.COM
WWW.KIMLEY-HORN.COM


[illegible]

C203

MATCHLINE - SEE SHEET C202

GRAPHIC SCALE IN FEET

0 25 50 100

A horizontal scale bar with four segments. The first segment is labeled '0', the second '25', the third '50', and the fourth '100'. The segments are black and white alternating.[illegible]

SITE DEVELOPMENT PLAN



APPROVAL PENDING
NOT FOR
CONSTRUCTION

SCALE:	AS NOTED
DESIGNED BY:	JSM
DRAWN BY:	GMS
CHECKED BY:	BAH

Kimley»Horn

© 2024 KIMLEY-HORN AND ASSOCIATES, INC.
 300 EAST 96TH STREET, SUITE 300
 ANAPOLIS, MD 44340
 CONTACT: BRETT HURT
 PHONE: 317-912-4120
 EMAIL: breth@kimleyhorn.com


1	REVISIONS PER TAC COMMENTS	4/24/25	PCW

Call 811


C204

ORIGINAL ISSUE:
4/24/2015
KHA PROJECT NO.
470150010



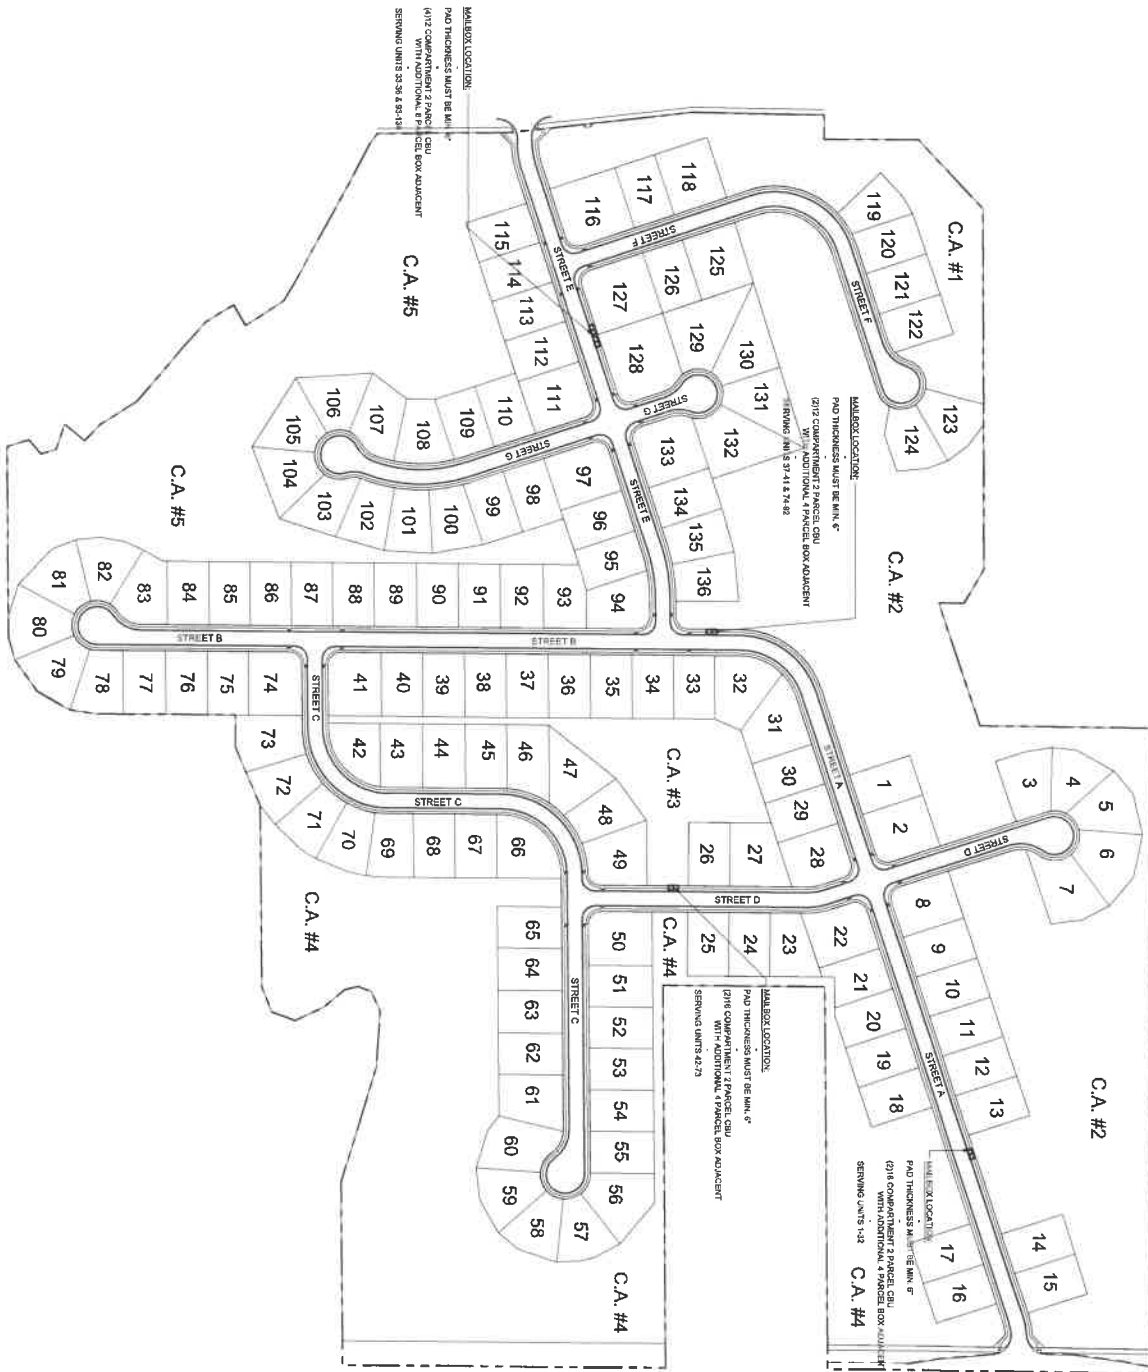

MAILBOX PLAN IS
PRELIMINARY AND
SUBJECT TO CHANGE

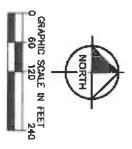

MONTCLAIRE
PRIMARY PLAT

MAILBOX PLAN




APPROVAL REQUIRED
NOT FOR
CONSTRUCTION

SCALE: AS NOTED
DESIGNED BY: JAH
DRAWN BY: GWS
CHECKED BY: BAH
2024 KIMLEY-HORN AND ASSOCIATES, INC.
500 EAST 16TH STREET, SUITE 300
DES MOINES, IOWA 50319
PHONE: 515-251-4123
WWW.KIMLEY-HORN.COM


Kimley-Horn

NO.	REVISIONS PER TAC COMMENTS	DATE	PCW BY
1		4/24/25	

ORIGINAL, ISSUE:
KHA PROJECT NO:
170150006
SHEET NUMBER
C500

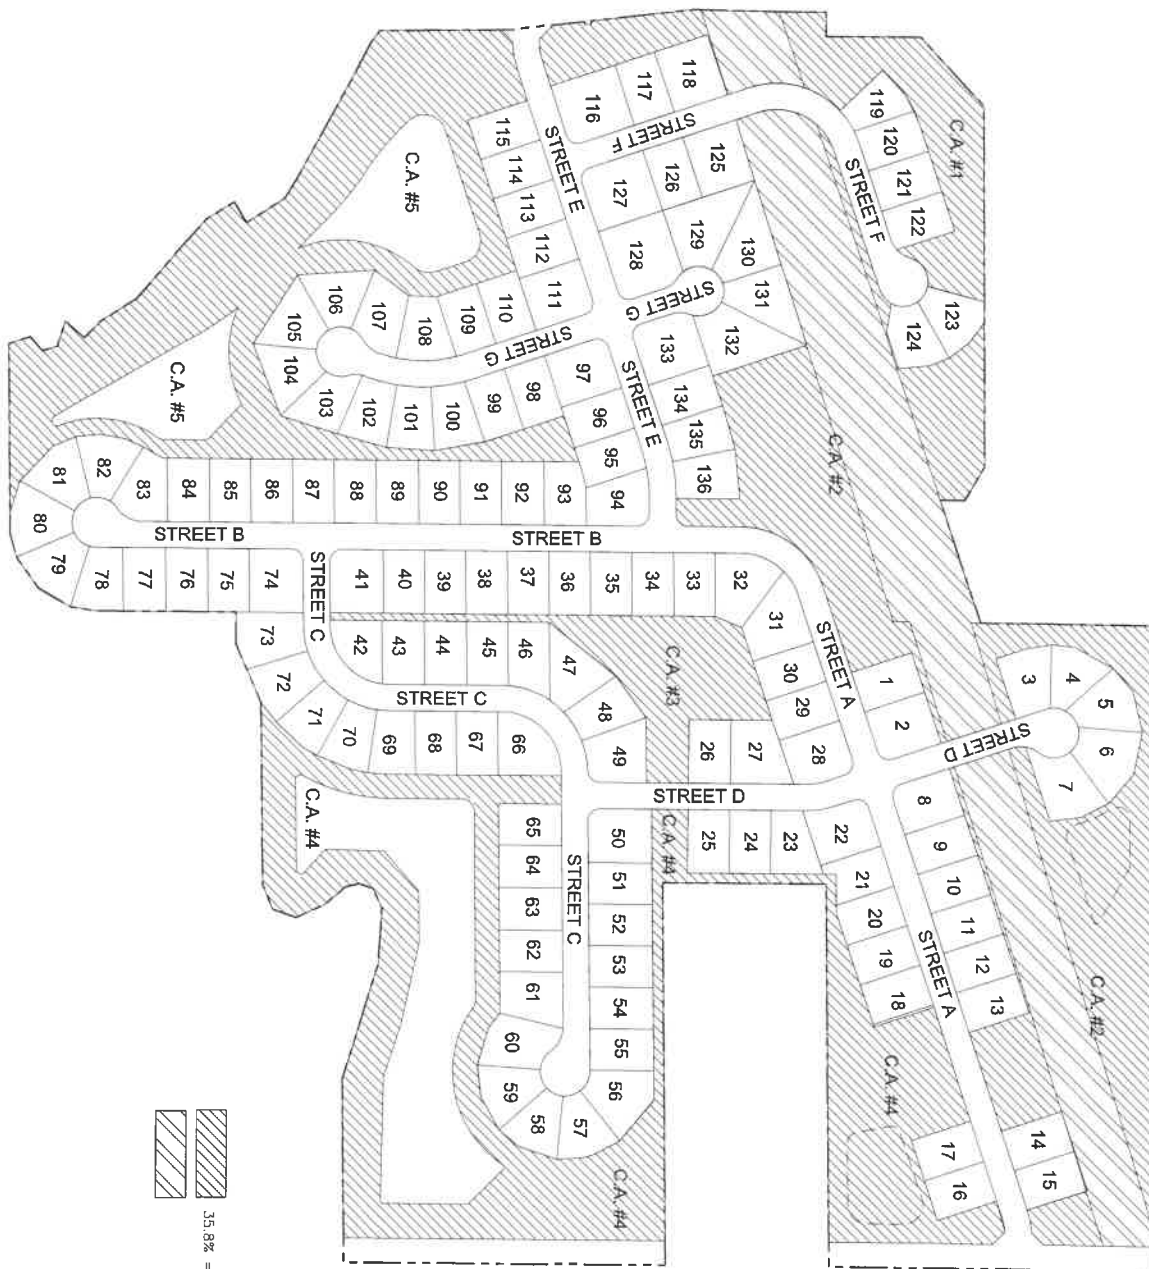

OPEN SPACE RATIO
 OPEN SPACE = 33.45 AC.
 GAS EASEMENT = 7.96 AC./2 = 3.98 AC.
 TOTAL ACREAGE = 93.35 AC.
 PONDS EXCLUDED

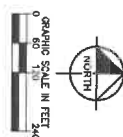

Call 811
 Before you dig
 Indiana Utilities Protection Service
 1-800-4-A-UTILITY

C500

ORIGINAL, ISSUED:
 KHA PROJECT NO.
 170150008
 SHEET NUMBER

MONTCLAIRE
 PRIMARY PLAT

OPEN SPACE
 PLAN




APPROVAL PENDING
 NOT FOR
 CONSTRUCTION


SCALE: AS NOTED
 DESIGNED BY: JWS
 DRAWN BY: GMS
 CHECKED BY: BAW
 2024 MILEY-HORN AND ASSOCIATES, INC.
 500 EAST 96TH STREET, SUITE 300
 INDIANAPOLIS, IN 46219
 CONTACT: BRITT LUFF
 PHONE: 317-538-4610
 EMAIL: BRITL@mh-horn.com
 WWW.MH-HORN.COM

REVISIONS PER TAC COMMENTS		DATE	PCW
No.	REVISIONS	DATE	BY
1		4/24/25	PCW

WEST ENTRANCE

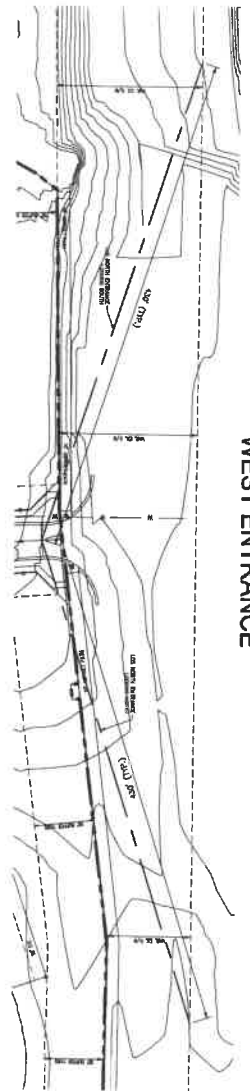

EAST ENTRANCE

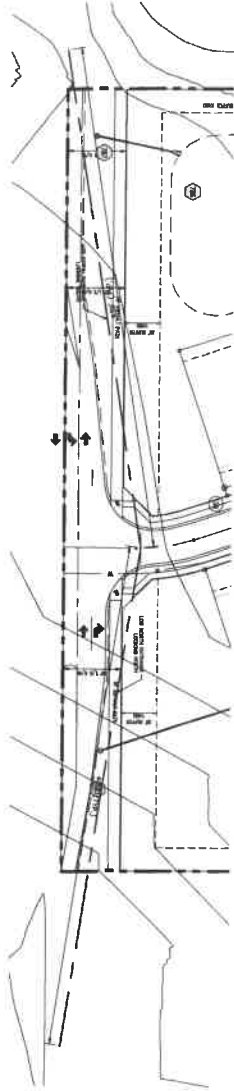


Intersection Sight Distance For Passenger Car		
Design Speed (mph)	Calculated (ft)	Design (ft)
15	143.3	145
20	191.1	195
25	238.0	240
30	286.7	290
35	334.4	335
40	382.2	385
45	430.0	430
50	477.8	480
55	525.5	530
60	573.3	575
65	621.1	625
70	668.9	670

Note: Intersection sight distance shown is for a stopped passenger car to turn right onto or cross a two-lane highway with no median and grades of 3% or flatter. For other conditions, the time gap should be adjusted and the required sight distance recalculated.


INTERSECTION SIGHT DISTANCE FOR PASSENGER CAR
TO TURN RIGHT FROM A STOP OR TO MAKE A CROSSING MANEUVER

Figure 46-1011

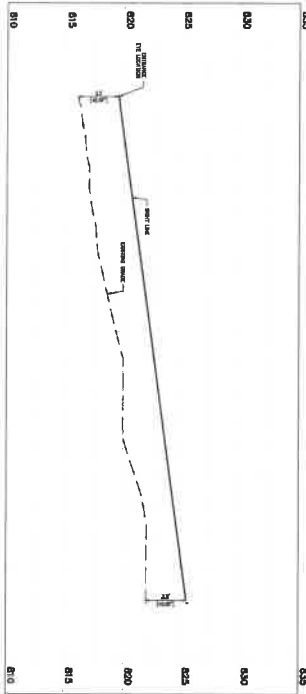


LOS LITTLE CHICAGO LOOKING NORTH

H:1"=50' : V:1"=5'

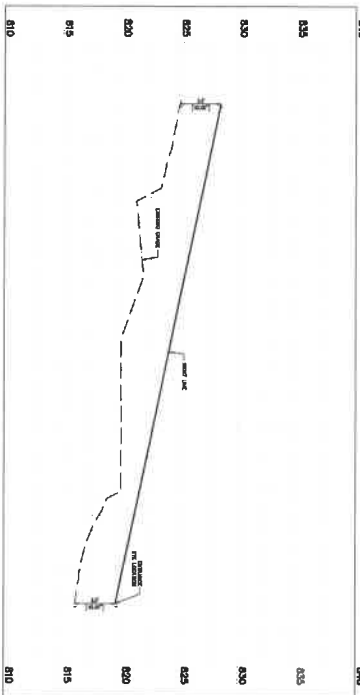


LOS LITTLE CHICAGO LOOKING SOUTH

H:1"=50' : V:1"=5'

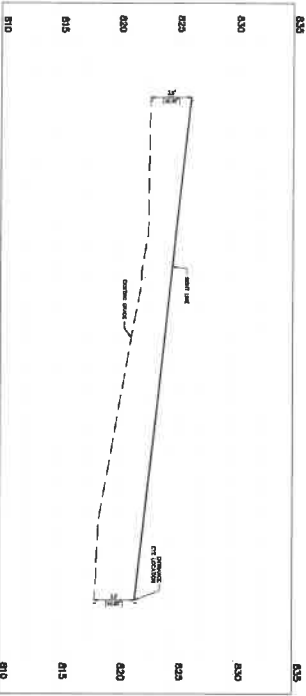

LOS MILL CREEK LOOKING NORTH

H:1"=50' : V:1"=5'

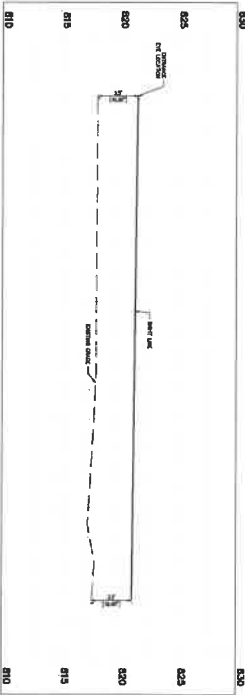

LOS MILL CREEK LOOKING SOUTH

H:1"=50' : V:1"=5'

APPROVAL RECORD
NOT FOR CONSTRUCTION


DRAWN BY: JSM
CHECKED BY: BAH
DATE: 04/23/2025
PROJECT: 17050036
SHEET: 1 OF 1

M/I HOMES

LINE OF SIGHT
PLAN

MONTCLAIRE
PRIMARY PLAT

ORIGINAL ISSUE:
MONTCLAIRE
PROJECT NO.
17050036
SHEET NUMBER
C600

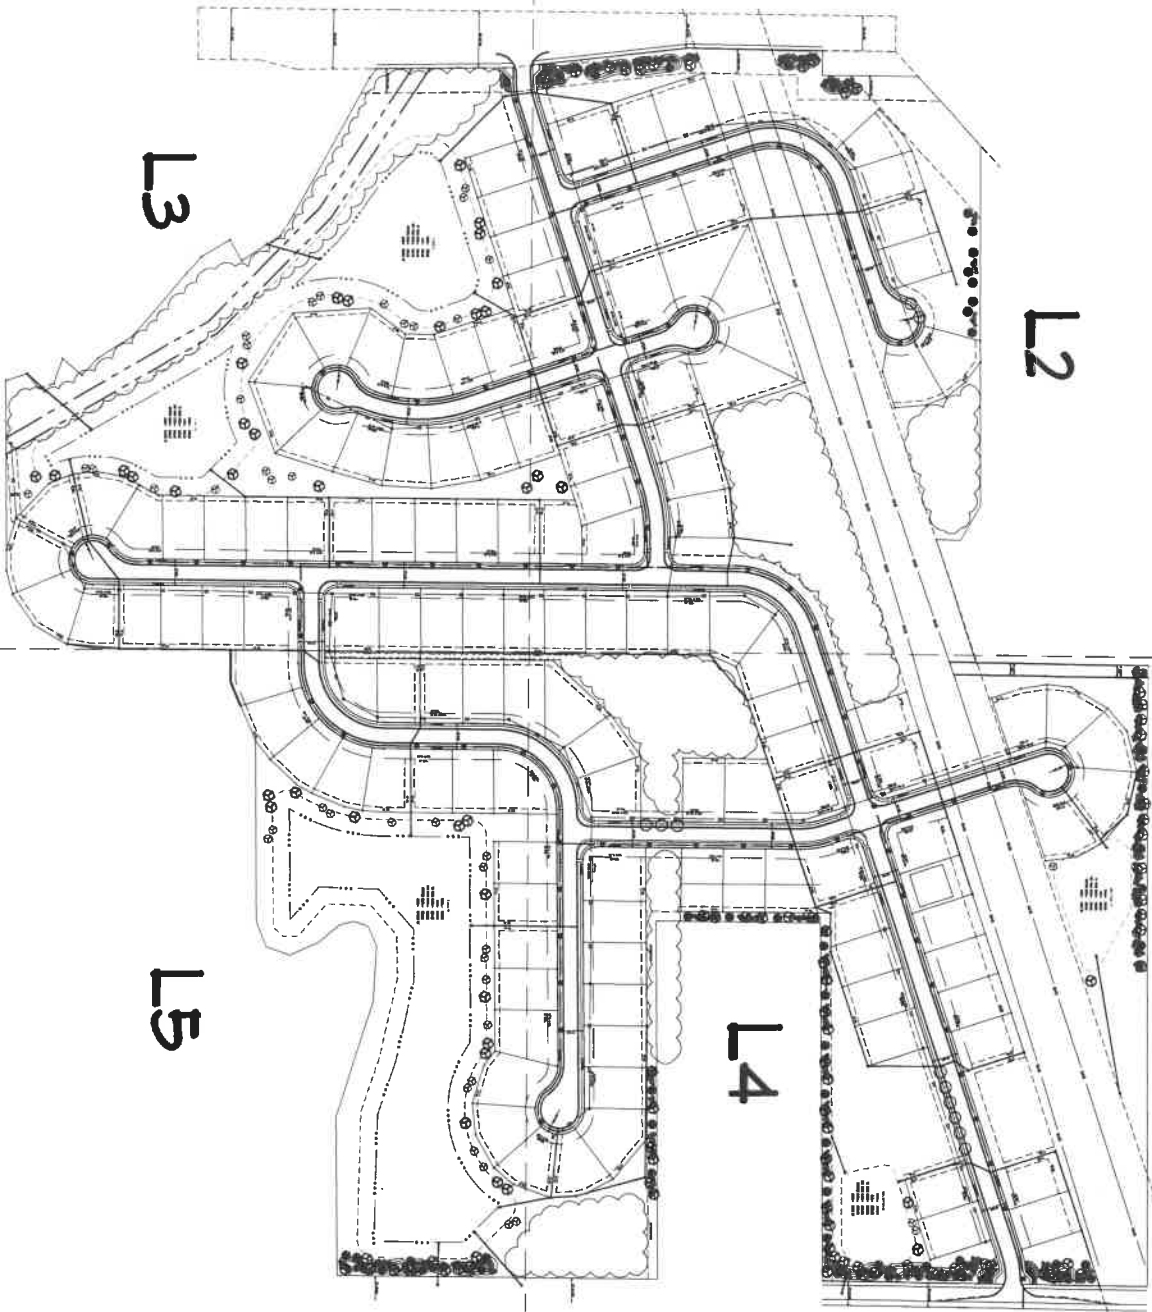

SHADE TREES			
NO.	SYMBOL	PLANT SPECIES	QUANTITY
1	(Symbol)	SHADE TREE	1
2	(Symbol)	SHADE TREE	1
3	(Symbol)	SHADE TREE	1
4	(Symbol)	SHADE TREE	1
5	(Symbol)	SHADE TREE	1
6	(Symbol)	SHADE TREE	1
7	(Symbol)	SHADE TREE	1
8	(Symbol)	SHADE TREE	1
9	(Symbol)	SHADE TREE	1
10	(Symbol)	SHADE TREE	1
11	(Symbol)	SHADE TREE	1
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13	(Symbol)	SHADE TREE	1
14	(Symbol)	SHADE TREE	1
15	(Symbol)	SHADE TREE	1
16	(Symbol)	SHADE TREE	1
17	(Symbol)	SHADE TREE	1
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28	(Symbol)	SHADE TREE	1
29	(Symbol)	SHADE TREE	1
30	(Symbol)	SHADE TREE	1
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33	(Symbol)	SHADE TREE	1
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NOT TO SCALE

M I HOMES
 2222 SOUTH BROAD STREET
 HOUSTON, TEXAS 77058
 281.460.0000
 www.mihomes.com

DESIGNED FOR

PROJECT NAME
 MONT CLAIRE


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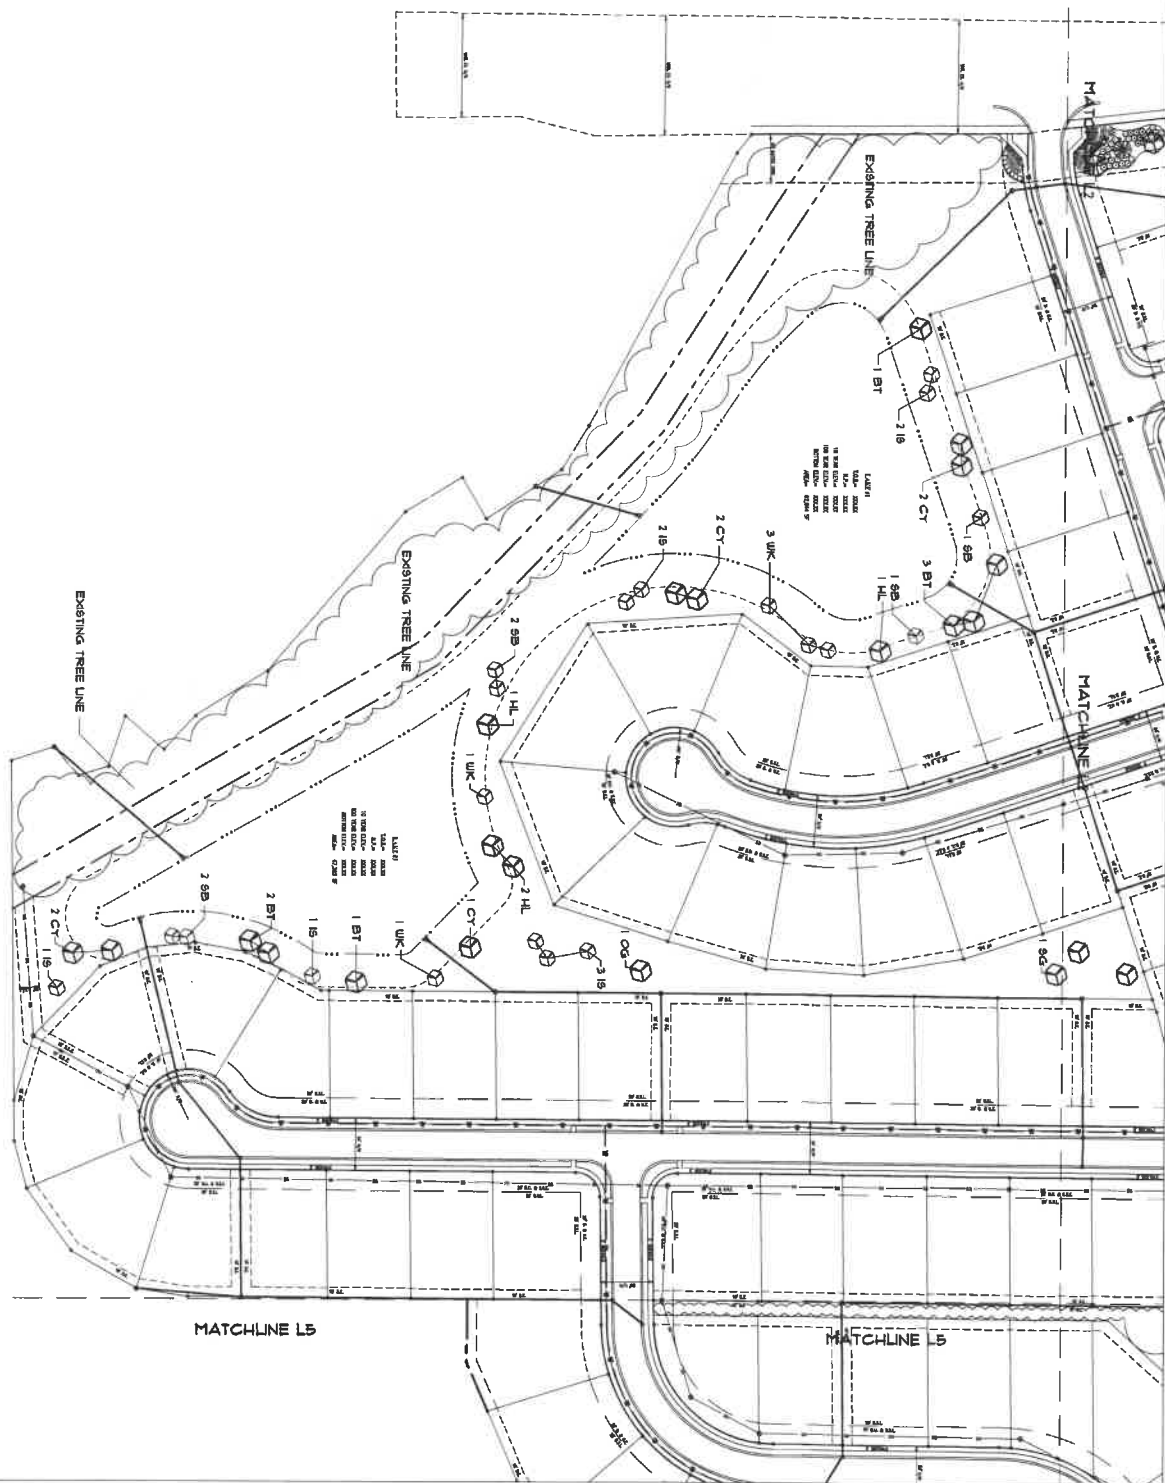
DESIGNER
 THOMAS KELLEY, P.L.A.



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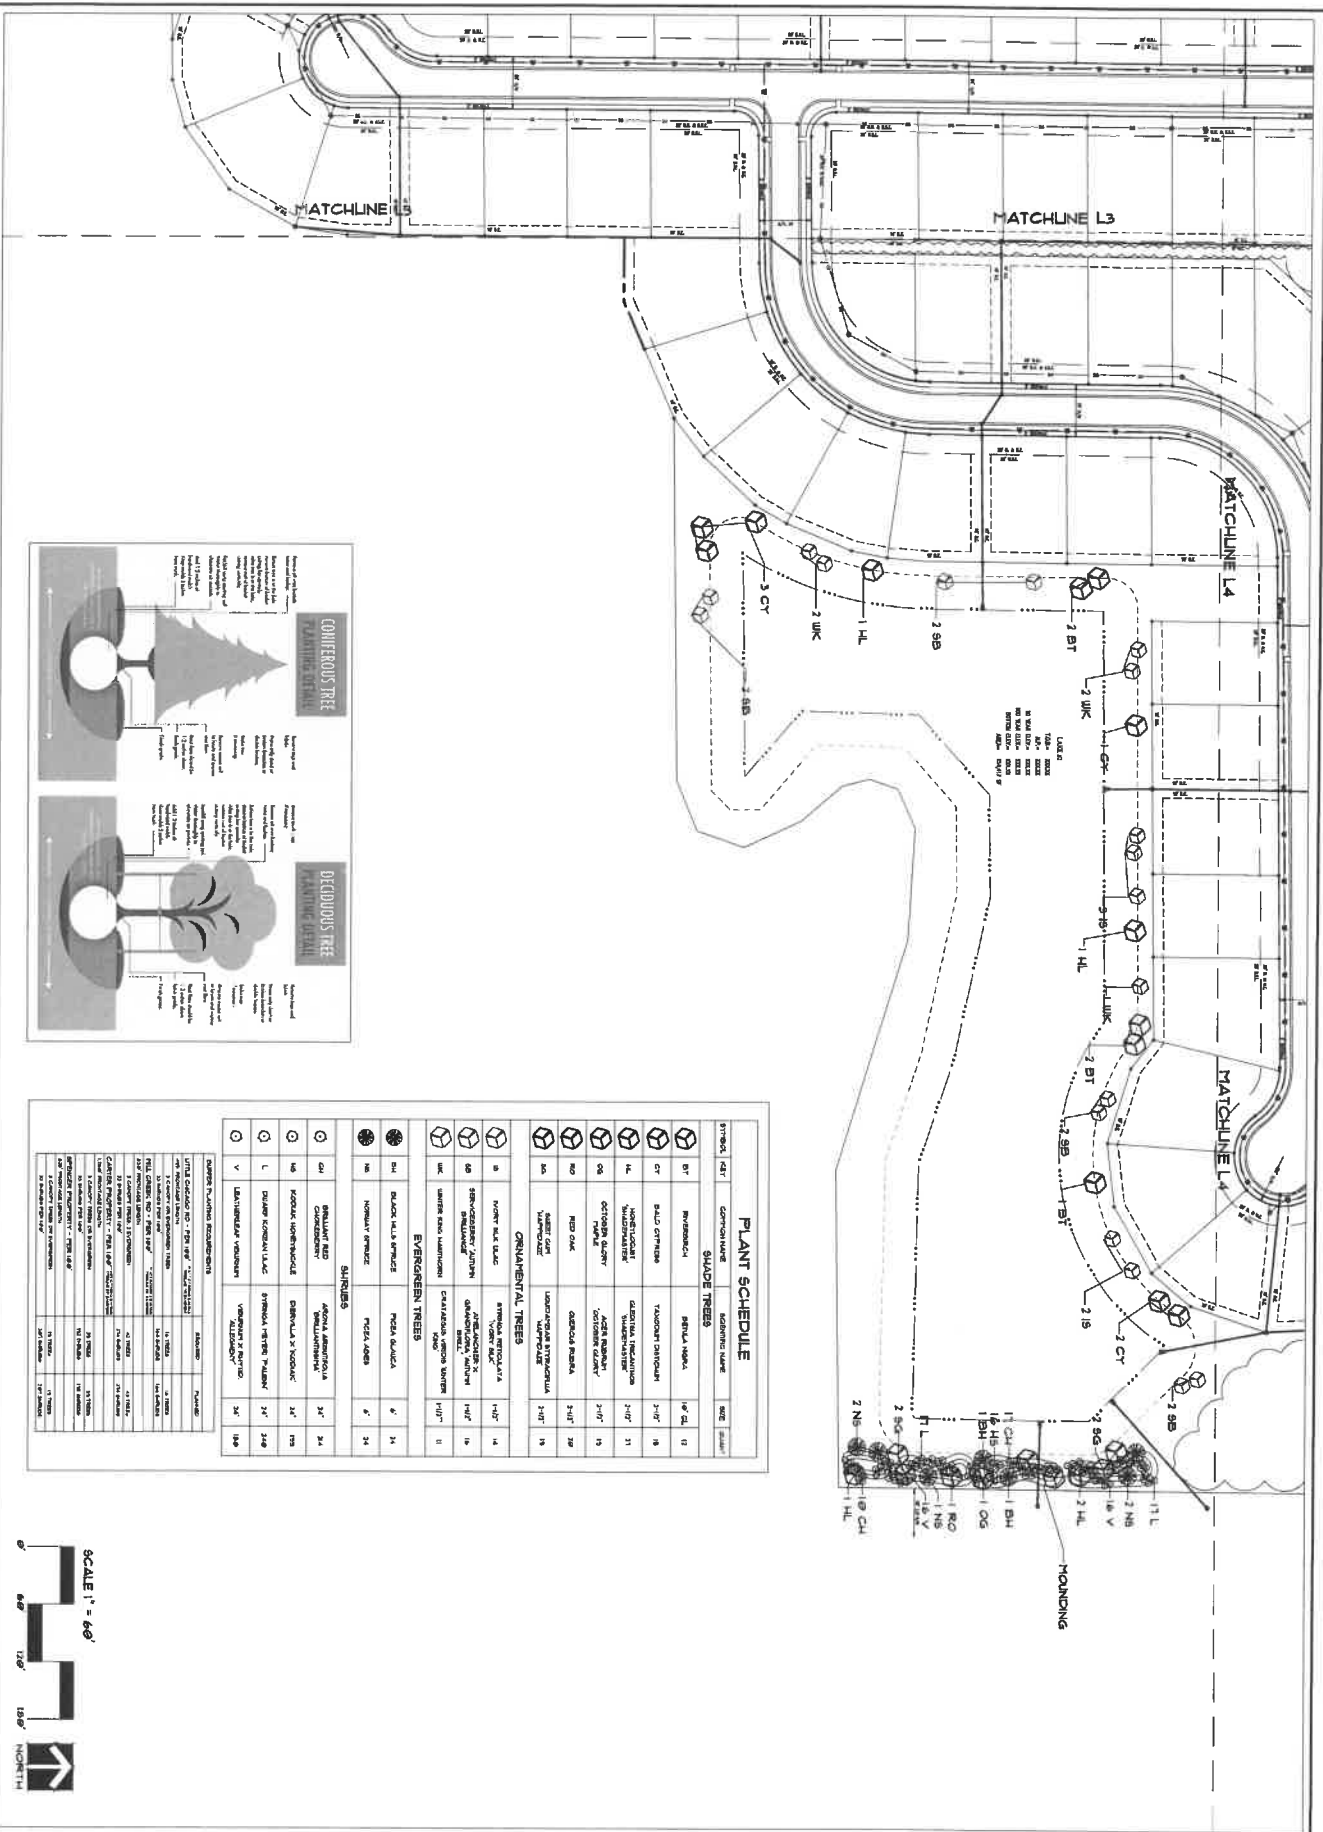
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SHEET







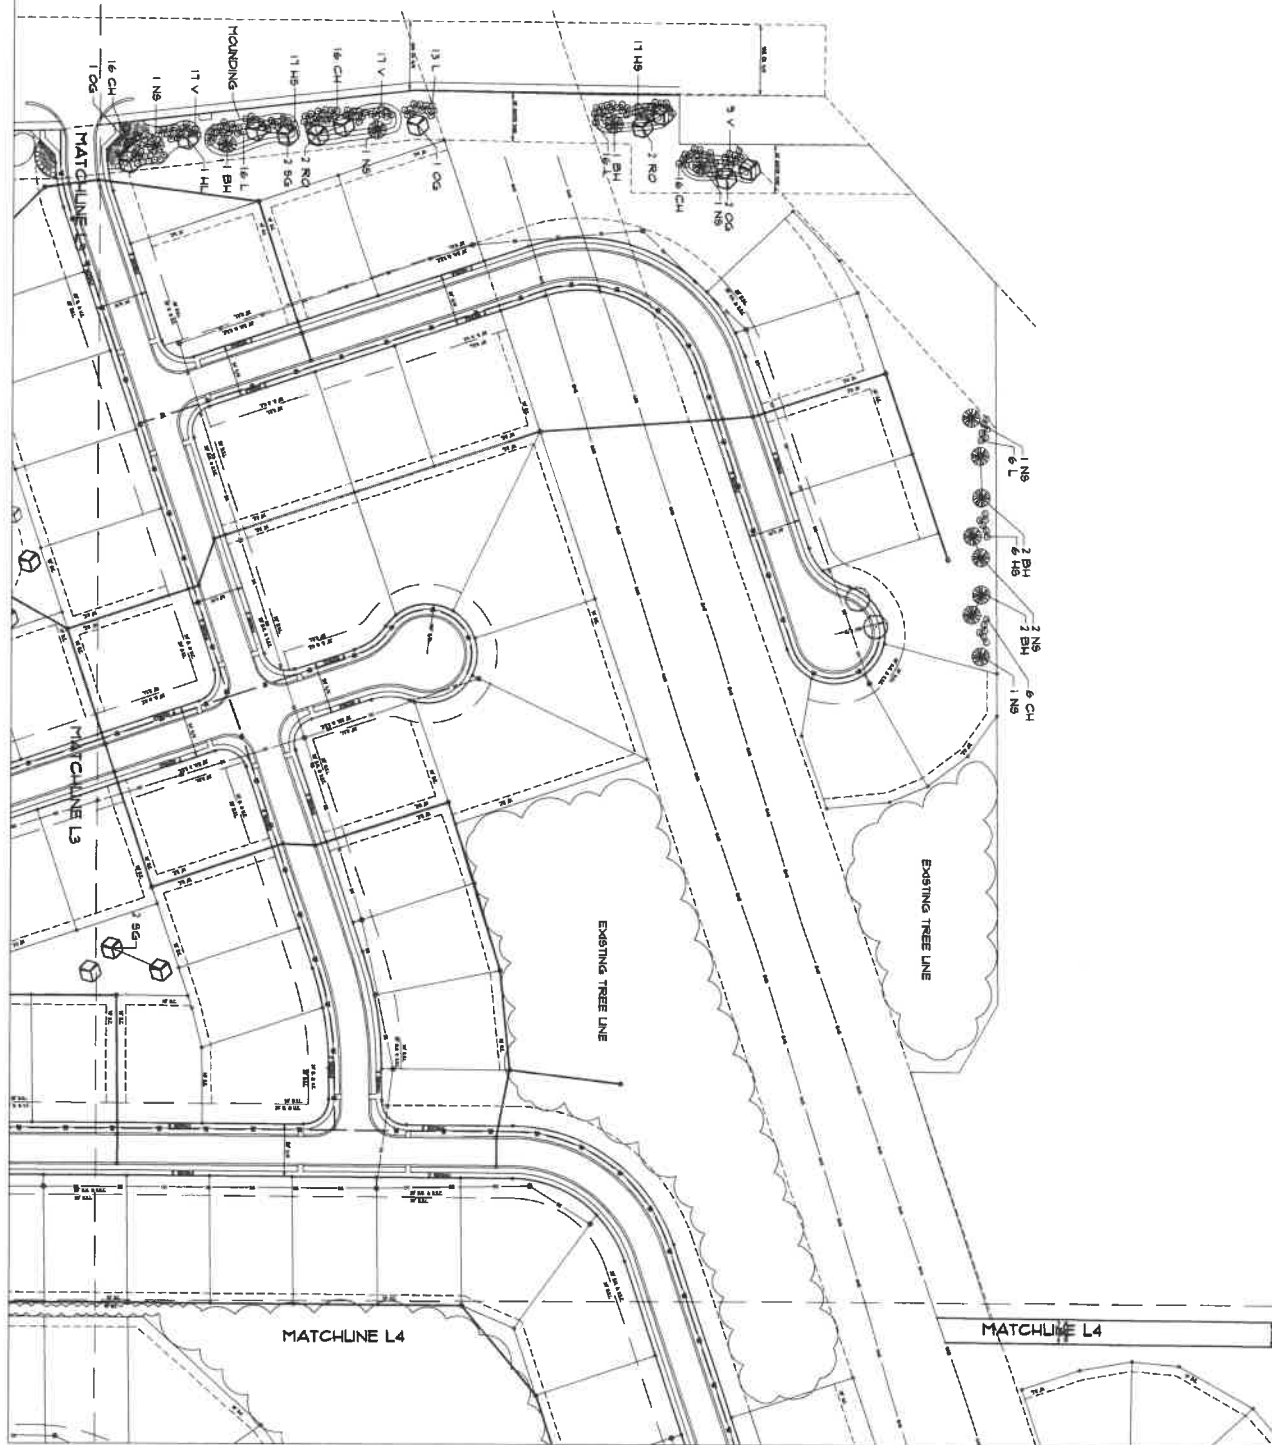

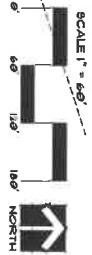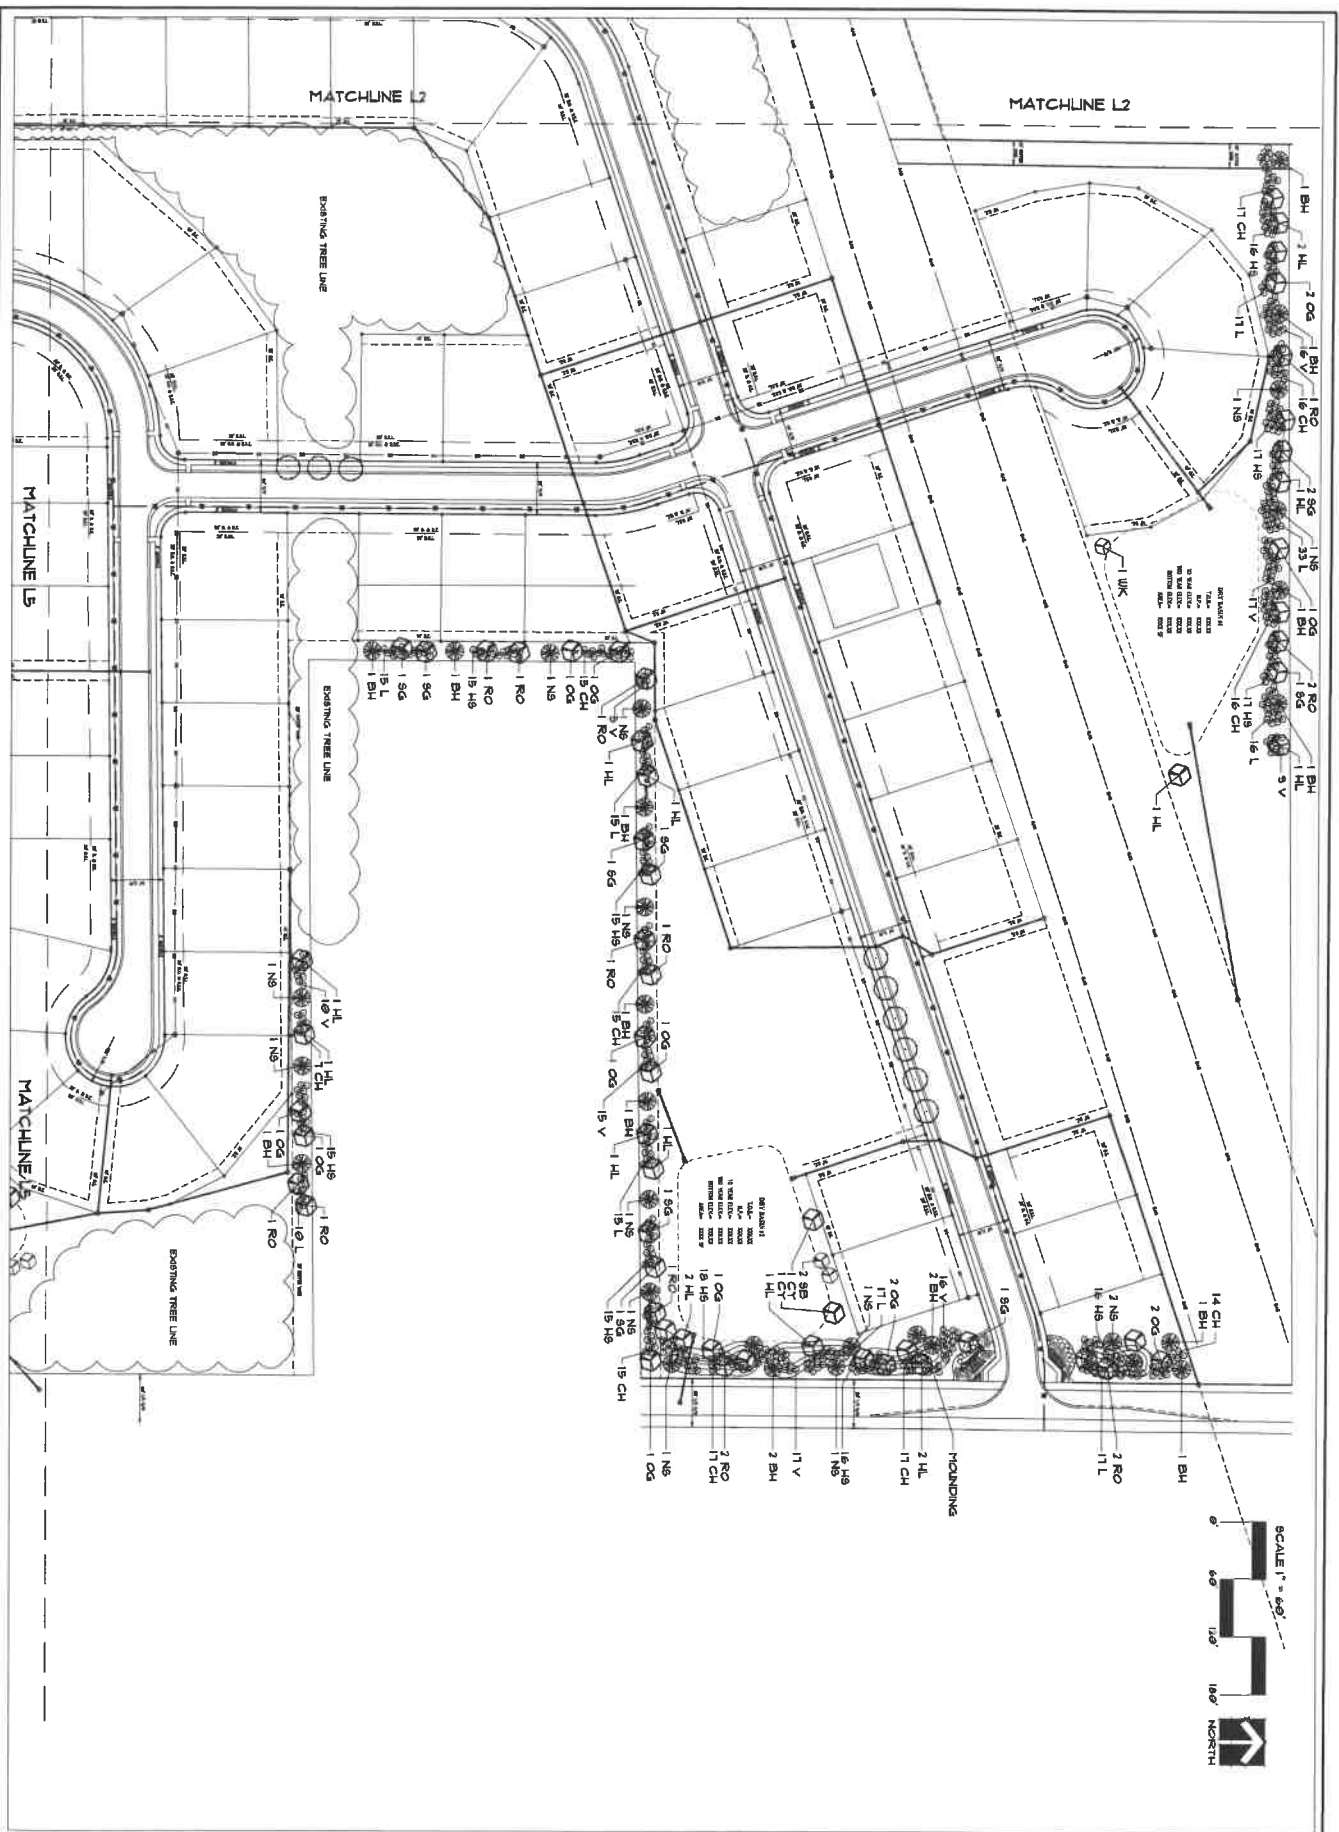DECIDUOUS TREE


Symbol for deciduous trees, showing a tree with a rounded canopy.

CONIFEROUS TREE

Symbol for coniferous trees, showing a tree with a pointed canopy.

SYMBOL	DEF	COMMON NAME	SCIENTIFIC NAME	SIZE	QUANTITY
BT	SHADE TREE	BURR OAK	QUERCUS MACROCARPA	4" DB, 12'	18
CR	SHADE TREE	CRABAPPLE	MALUS DOUGLASII	2-4" DB, 12'	18
HL	SHADE TREE	HAWTHORN	CRATAEGUS PHAEOFLORA	2-4" DB, 12'	18
SB	SHADE TREE	SMOKED BAY	PERsea BAY	2-4" DB, 12'	18
WK	SHADE TREE	WILLOW	SALIX BACULATA	2-4" DB, 12'	18
NS	SHADE TREE	NORWAY SPRUCE	PICEA ABIES	2-4" DB, 12'	18
CH	SHADE TREE	CHERRY	PRAIRIE CHERRY	2-4" DB, 12'	18
HS	SHADE TREE	HOLY SHAM	ILICIA	2-4" DB, 12'	18
BH	SHADE TREE	BURR OAK	QUERCUS MACROCARPA	2-4" DB, 12'	18
OG	SHADE TREE	ORANGE GUM	COCAOBA	2-4" DB, 12'	18
RO	SHADE TREE	RED OAK	QUERCUS RUBRA	2-4" DB, 12'	18
NS	SHADE TREE	NORWAY SPRUCE	PICEA ABIES	2-4" DB, 12'	18



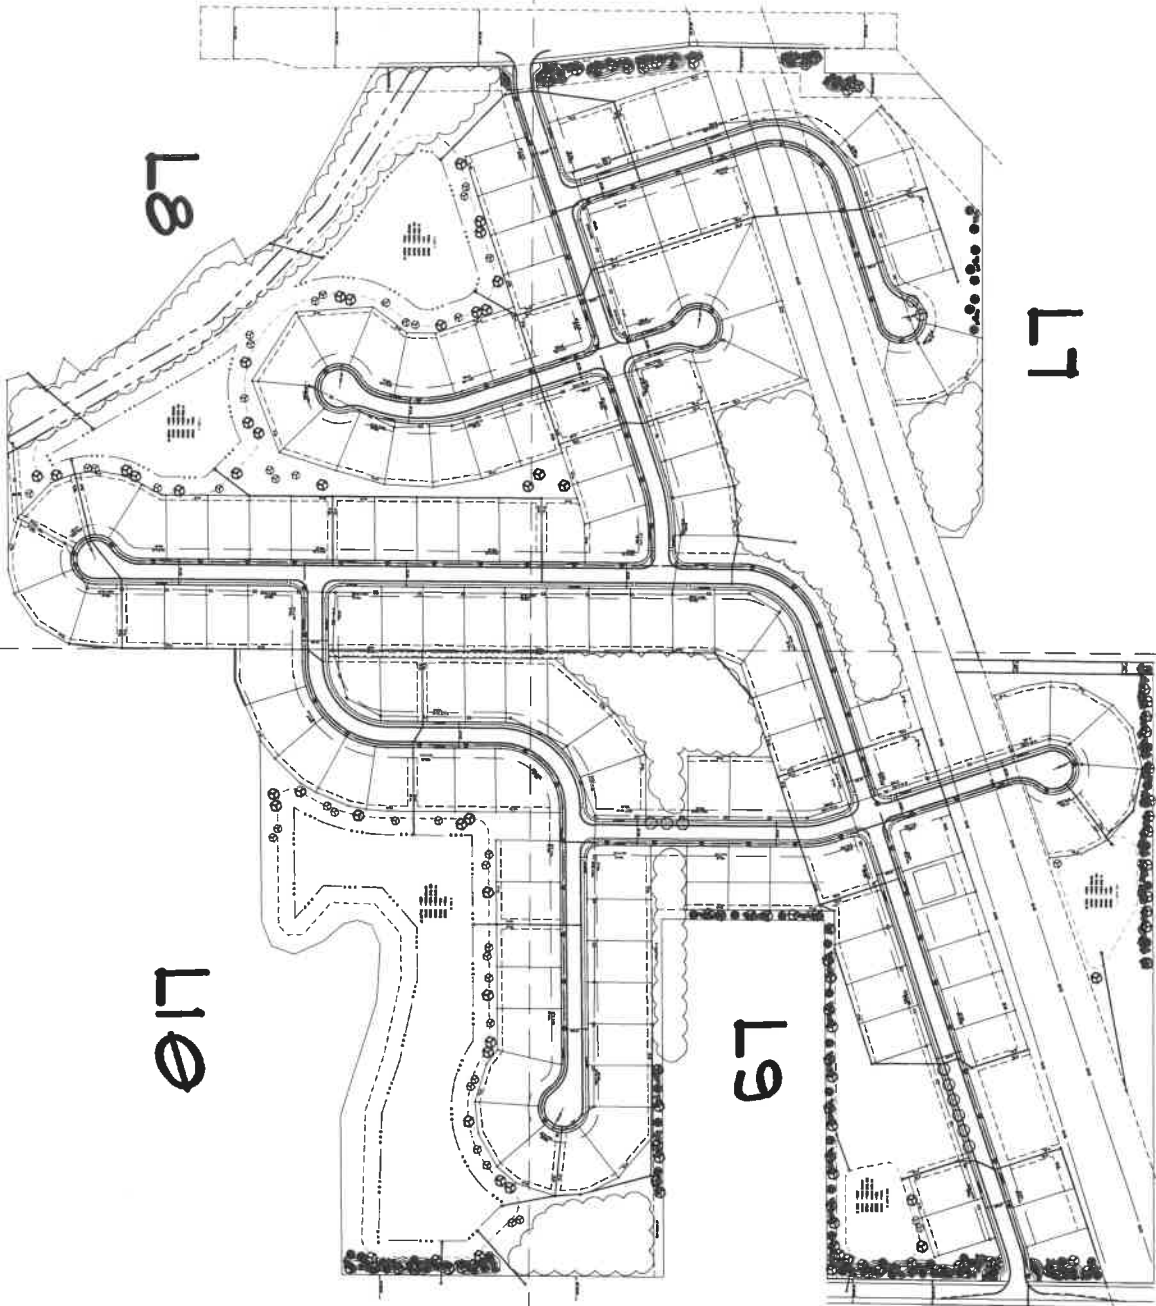

PLANT SCHEDULE - STREET TREES

SYMBOL	DESCRIPTION	QUANTITY	DATE	BY
1	PLANTING TREES - 1" DIA. AT 10' SPACING	1	10/10/10	J. H. H.
2	PLANTING TREES - 2" DIA. AT 10' SPACING	1	10/10/10	J. H. H.
3	PLANTING TREES - 3" DIA. AT 10' SPACING	1	10/10/10	J. H. H.
4	PLANTING TREES - 4" DIA. AT 10' SPACING	1	10/10/10	J. H. H.
5	PLANTING TREES - 5" DIA. AT 10' SPACING	1	10/10/10	J. H. H.
6	PLANTING TREES - 6" DIA. AT 10' SPACING	1	10/10/10	J. H. H.
7	PLANTING TREES - 7" DIA. AT 10' SPACING	1	10/10/10	J. H. H.
8	PLANTING TREES - 8" DIA. AT 10' SPACING	1	10/10/10	J. H. H.
9	PLANTING TREES - 9" DIA. AT 10' SPACING	1	10/10/10	J. H. H.
10	PLANTING TREES - 10" DIA. AT 10' SPACING	1	10/10/10	J. H. H.

Plant to Grow
LANDSCAPING
1000 S. W. 10th Ave.
Fort Lauderdale, FL 33304
Tel: 754.561.1234
Fax: 754.561.1235
www.planttogrow.com

DESIGNED FOR
M.I. HOMES
1000 S. W. 10th Ave.
Fort Lauderdale, FL 33304
Tel: 754.561.1234
Fax: 754.561.1235
www.mihomes.com

PROJECT NAME
MONT CLAIRE


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SHEET NAME
STREET TREE PLAN


DESIGNER
THOMAS PELLEGY, P.L.L.C.
DATE: MAY 15, 2010

NOT TO SCALE

L6

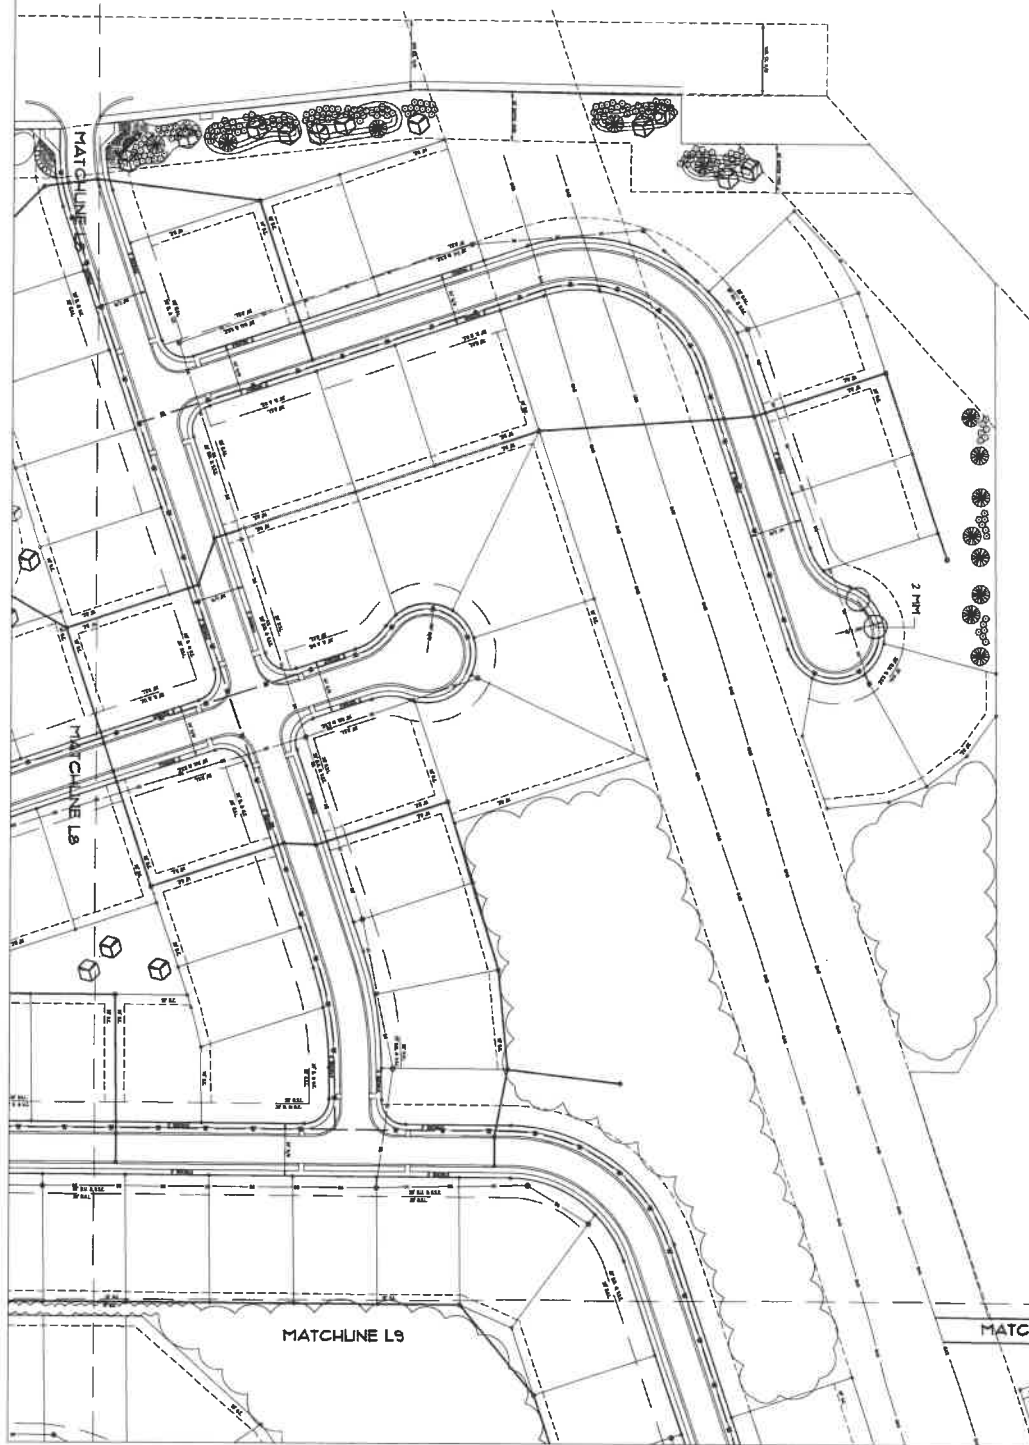

SCALE 1" = 60'
 0' 60' 120' 180'
 NORTH

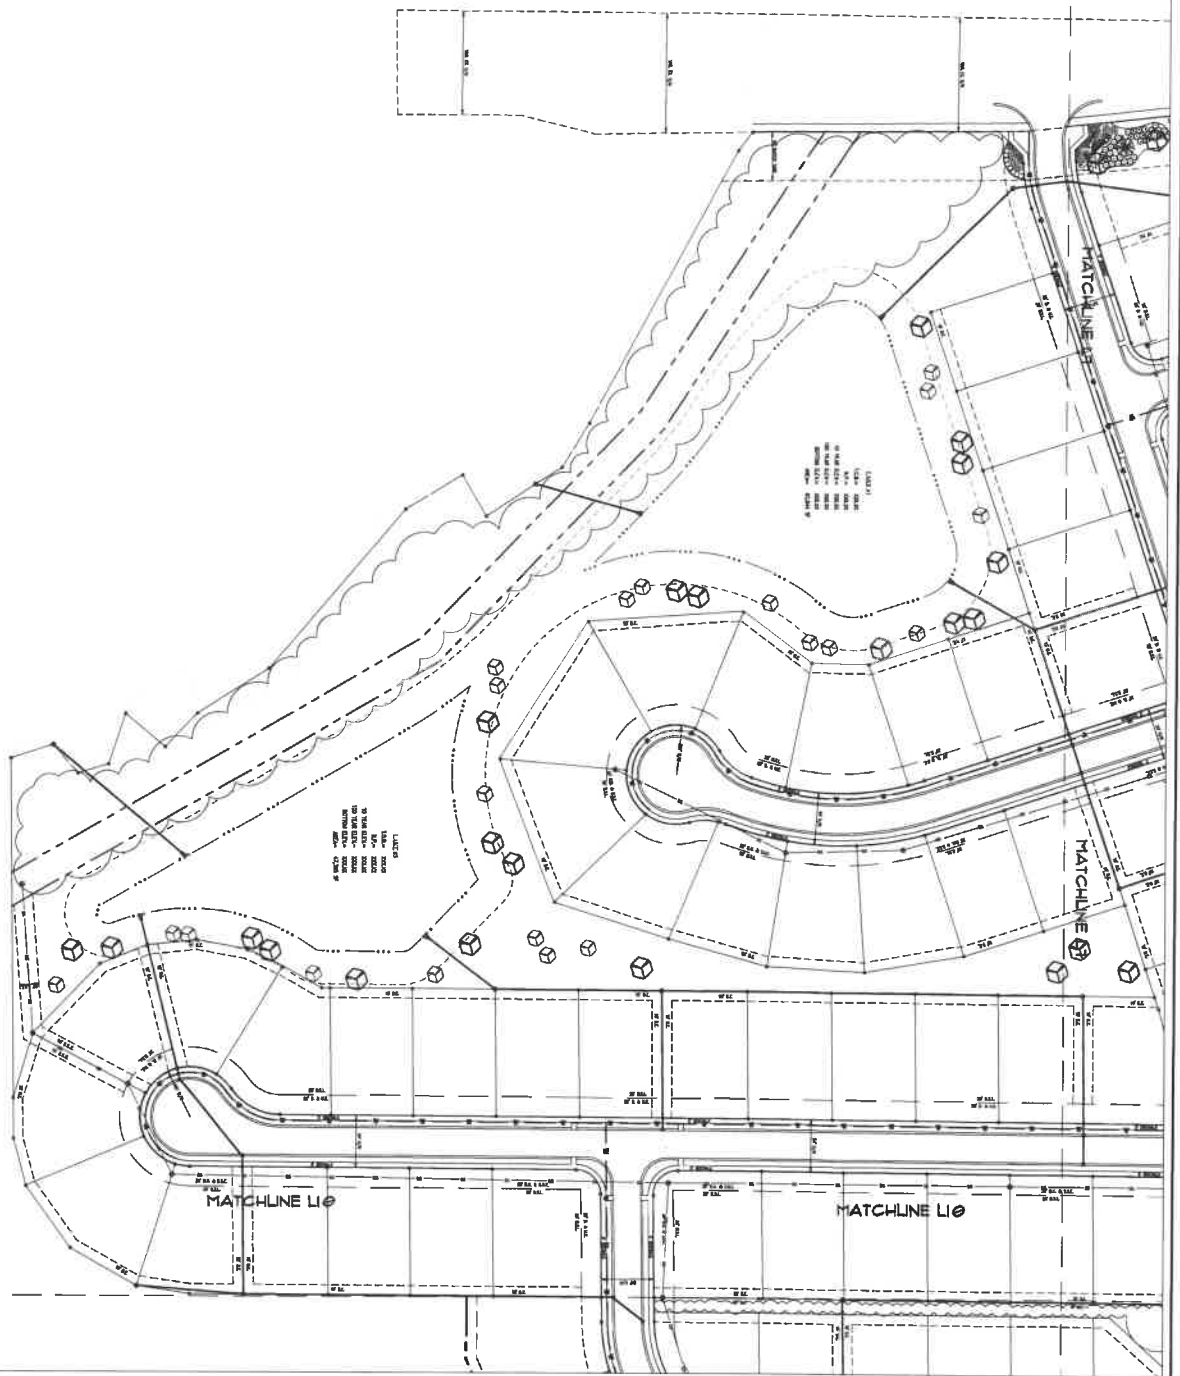

L8

SHEET


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 THOMAS PELLEGY, P.L.A.
 DATE: MAY 15, 2025

SHEET NAME
 STREET TREE PLAN


PROJECT NAME
 MONT CLAIRE

NOBLESVILLE, IN

MI HOMES
 1700 N. MIAMI AVENUE
 SUITE 100
 NORTHERLEIGH, IN 46051
 (317) 841-1111
 www.mi-homes.com
 DESIGNED FOR
 MI HOMES
 LANDSCAPING
 1700 N. MIAMI AVENUE
 SUITE 100
 NORTHERLEIGH, IN 46051
 (317) 841-1111
 www.mi-homes.com

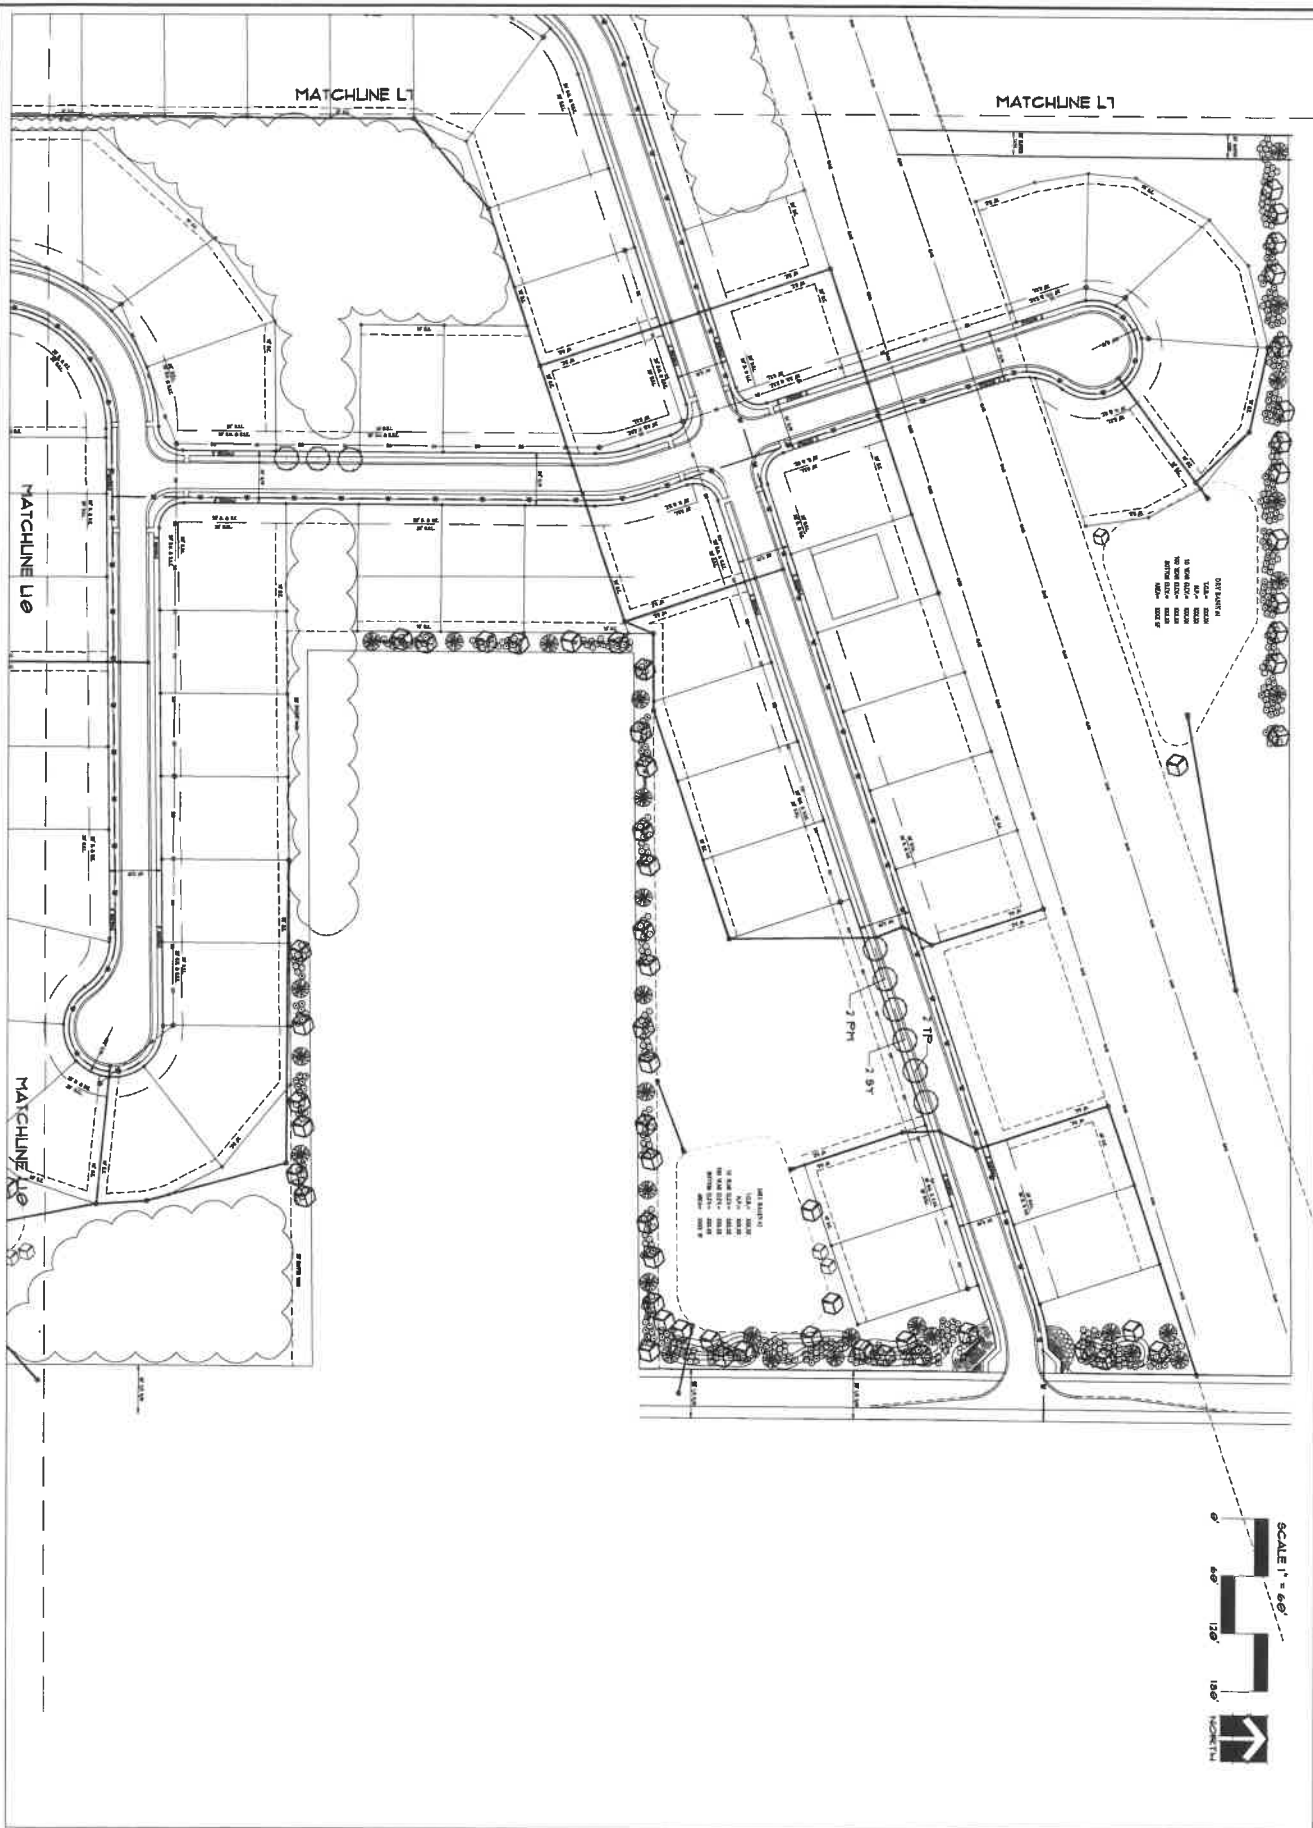

<p>19</p> <p>SHEET</p>	<p>DESIGNER THOMAS PELLEGAT, P.L.L.C.</p> <p>DATE: MAY 15, 2025</p>	<p>SHEET NAME</p> <p>STREET TREE PLAN</p>	<p>PROJECT NAME</p> <p>MONT CLAIRE</p> <p>NOBLESVILLE, IN</p>	<p>M I HOMES</p> <p>LANDSCAPING</p> <p>3275 South 500 East Provo, UT 84607 (801) 734-1111 www.mihomeslandscaping.com</p> <p>DESIGNED FOR</p>
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DECIDUOUS TREE PLANTING DETAIL

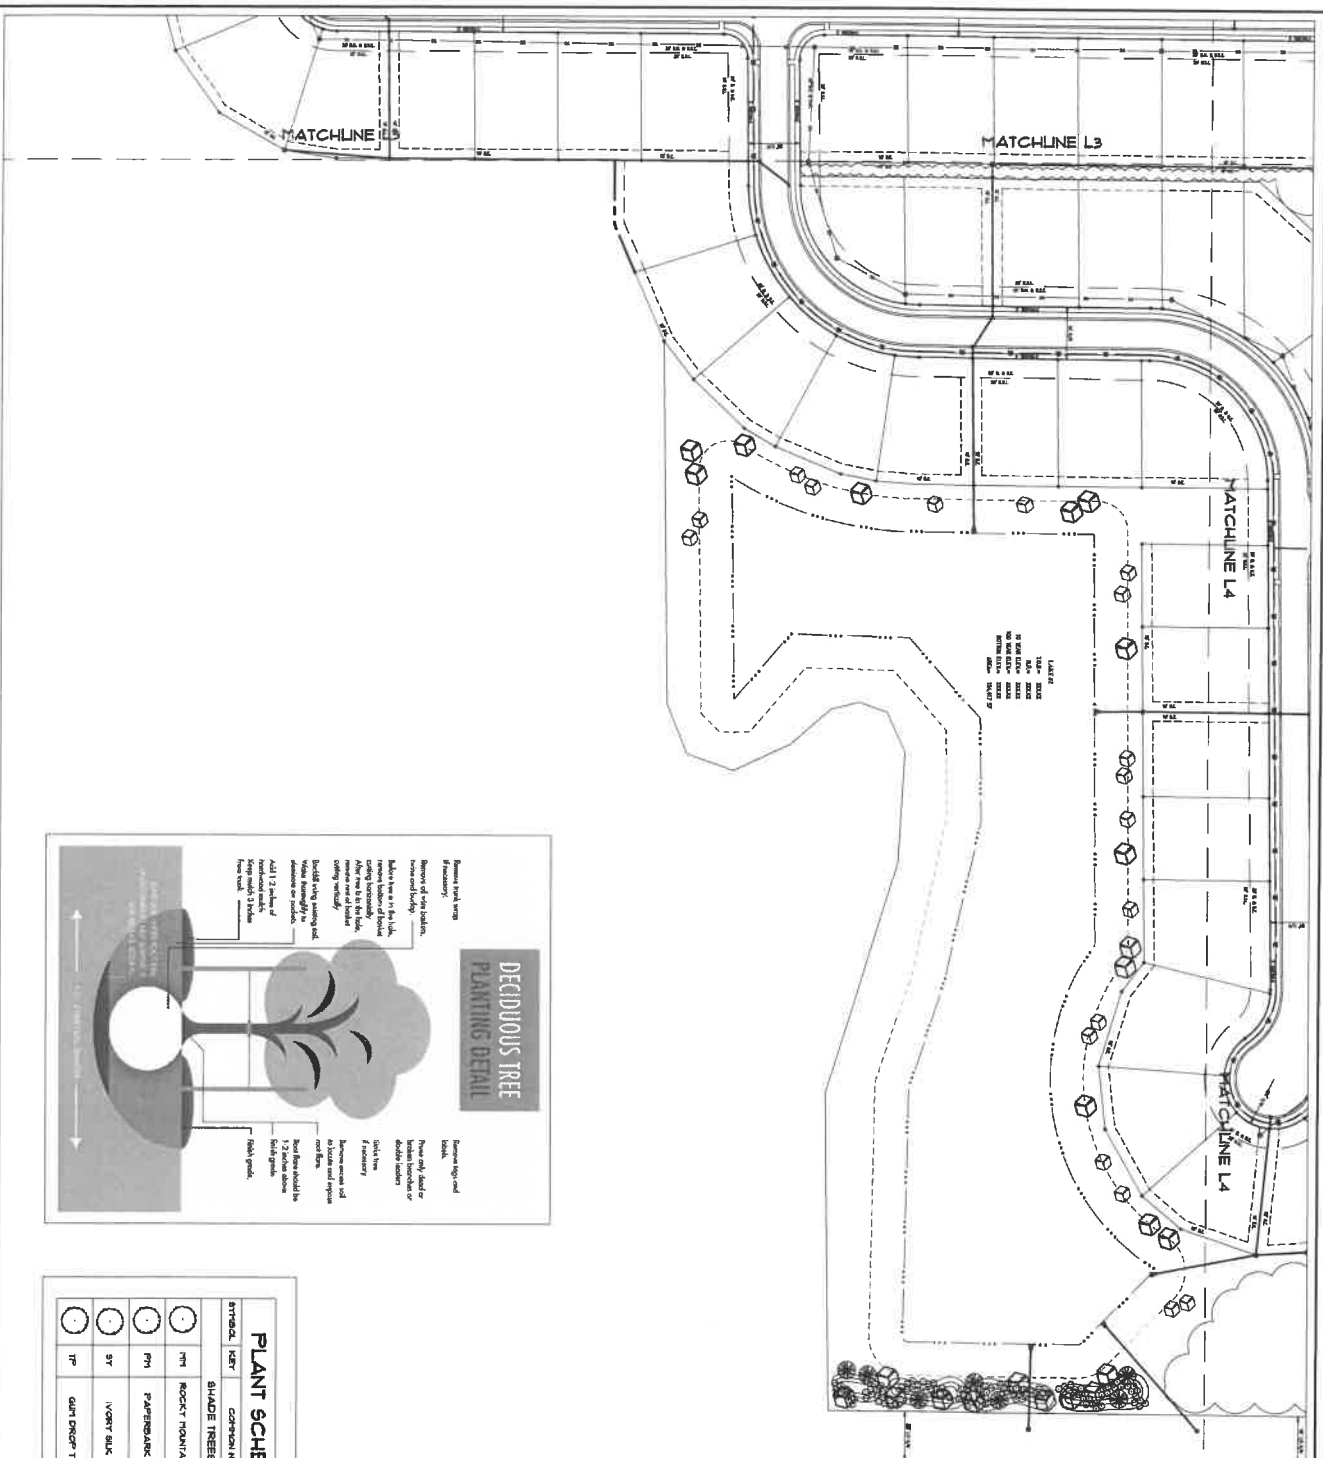
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1. Remove topsoil and backfill with topsoil. 2. Remove of any existing trees and stumps. 3. Backfill with topsoil. 4. After new tree is in place, water thoroughly. 5. After new tree is in place, water thoroughly. 6. After new tree is in place, water thoroughly.

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PLANT SCHEDULE - STREET TREES

SYMBOL	KEY	CORPORATION NAME	SCIENTIFIC NAME	SIZE	QUANTITY	REMARKS
○	PM	ROCKY MOUNTAIN MAPLE	ACER GRANDIDENTATUM	2-1/2"	3	6'
○	PM	FLORIDA PALM	ACER OERSTEDT	2-1/2"	2	6'
○	ST	IVORY BARK LILAC	SYMPLOCARPA FOETIDA	2-1/2"	2	6'
○	TP	GRAND PINE	PINUS GRANDIS	2-1/2"	2	6'



SCALE 1/8" = 1'

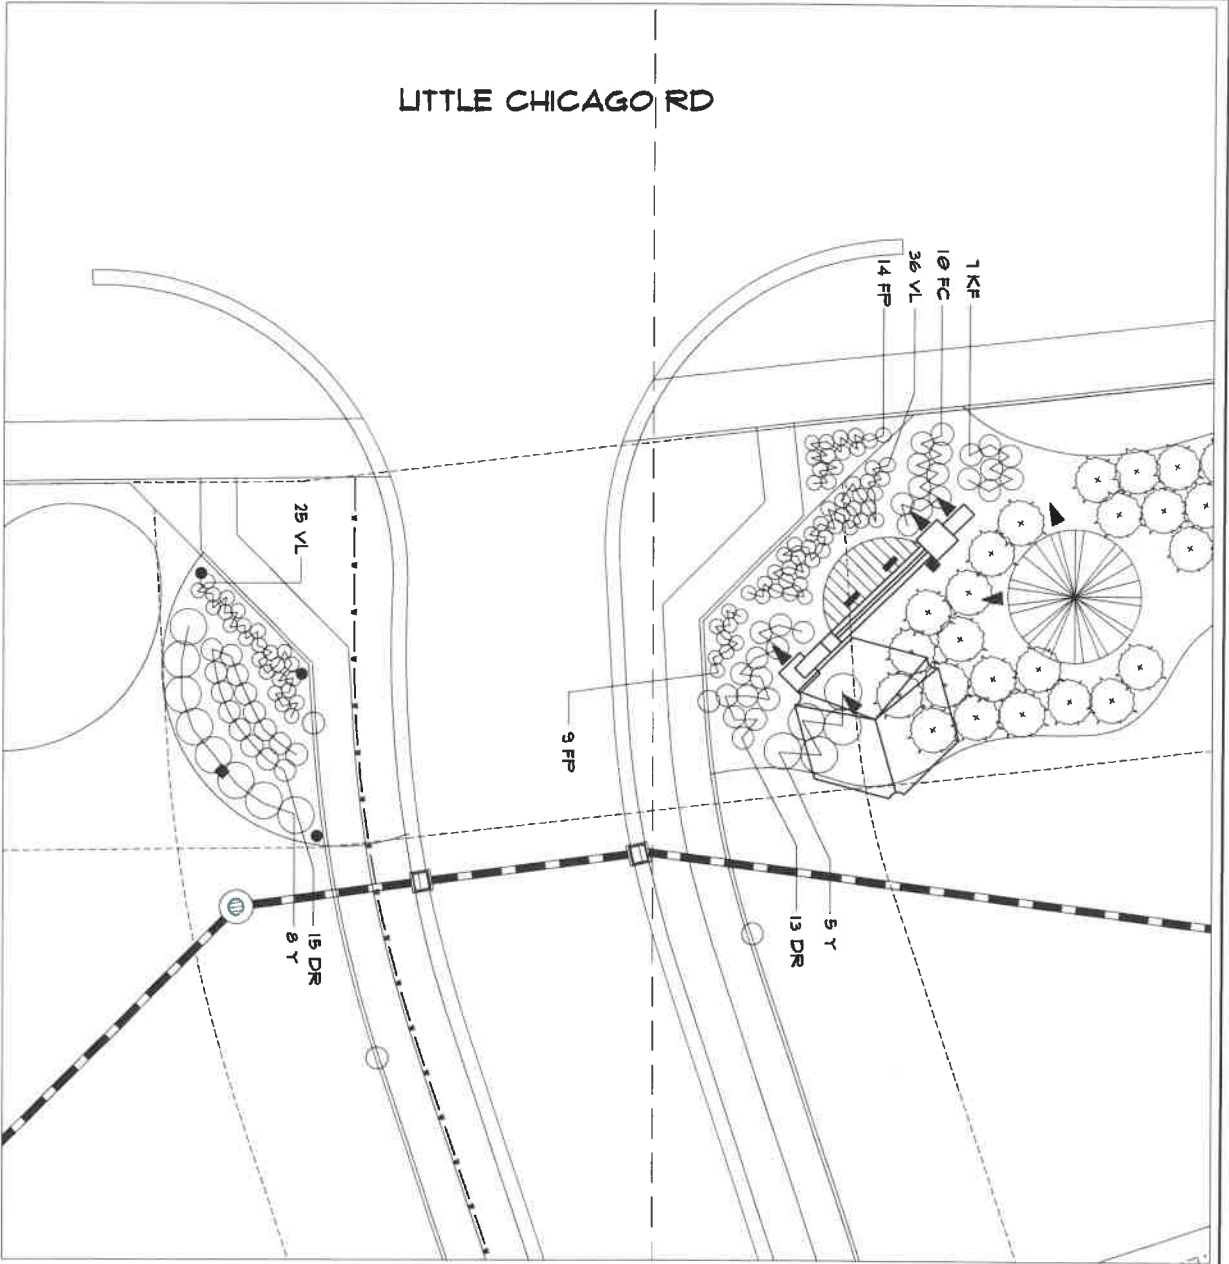0' 8' 16' 24'

NORTH

LITTLE CHICAGO RD - PLANT SCHEDULE			
SYMBOL	QTY	COMMON NAME	REMARKS
SHRUBS			
○	DR	DRY ROSE HEDG	10
○	FC	WINTERBERRY	10
○	VL	VALENTINE	10
○	Y	YUKON	10
PERENNIALS			
○	FP	FLORAL PINK	10
○	VL	VALENTINE	10
SPERMATOPHYTES			
○	DR	DRY ROSE HEDG	10
○	FC	WINTERBERRY	10
○	VL	VALENTINE	10
○	Y	YUKON	10

LIGHTING SCHEDULE			
SYMBOL	QTY	COMMON NAME	REMARKS
○	DR	DRY ROSE HEDG	10
○	FC	WINTERBERRY	10
○	VL	VALENTINE	10
○	Y	YUKON	10



PROJECT NAME

MONT CLAIRE

NOBLESVILLE, IN

SHEET NAME

LITTLE CHICAGO RD
PLANTING PLAN

DESIGNER

THOMAS PELLEGY, PLA

DATE: MAY 19, 2015

SHEET

11

DESIGNED FOR

M I HOMES

3275 SOUTH 500 EAST
MONTICELLO, IN 46054

DATE: MAY 19, 2015



LIGHTING SCHEDULE

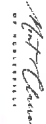


EXHIBIT C-1

SINGLE FAMILY RESIDENTIAL ARCHITECTURAL STANDARDS

(Page 1 of 2)

Architectural Standards – MontClaire			
General/ Miscellaneous	Floor Area/Dwelling Unit (Minimum)	One-Story	1,800 sf
		Two-Story	2,000 sf
	Building Height (Maximum)		35 feet
	*Corner Breaks (Minimum)	Primary Architectural Plane	Ranch = 3 two-story = 4
		Secondary Architectural Plane	2
	Porch (does not apply to covered stoop/entryway, that is not a porch)	Required	Not required
		Area (Minimum)	Not applicable, 6' in depth when provided
Materials	Masonry Percentage (Minimum)	Primary Architectural Plane	15%
		Secondary Architectural Plane	Not applicable
	Approved Materials	Fiber Cement Board	Permitted
		Masonry	Permitted
		Wood	Permitted
		Chimneys: Direct vent – non-masonry	Permitted
		Vinyl and Aluminum siding	Not permitted
		Soffits and Rake Boards Vinyl or aluminum	Permitted
Roof	Roof Pitch (Minimum)	Primary Ridge unless architecture style suggests less.	6/12
	**Roof Ridgelines (Minimum)	One-Story	3
		Two-Story	3
	Roof Overhang (Minimum)	All Architectural Planes – from framing	12 inches
	Allowable Vent Location (Roof)	Primary Architectural Plane	Yes
		Secondary Architectural Plane	Yes
Windows	Window Size (Minimum)	Standard Window	7 sf
		Accent Window (accent windows adding to 8 SF equals 1 window)	4 sf
	***Number of Windows (Minimum)	Primary Architectural Plane	Ranch = 3 2-story = 3
		Secondary Architectural Plane	Ranch = 2 2-story = 2
		Total Aggregate (doors count as windows)	Ranch = 10 2-story = 14
	Window Treatment Required	Primary Architectural Plane	Yes
		Secondary Architectural Plane	No

Garage	Garage Location	Primary Architectural Plane	No door
		Primary Architectural Plane (Corner Lot)	Side Load Required
		Secondary Architectural Plane	Permitted
	Garage Door Percentage, Primary Architectural	One-Story	Not applicable
		Two-Story	Not applicable
	****Garage Windows Required		Yes

Applicable Footnotes:

- (1) Window Treatment includes shutters, wood trim wrap, or brick detail surround.
- (2) Ridge vent not included in restricted vent type on primary architectural plane.
- (3) The minimum overhang shall be measured from framing and shall be 8" in masonry areas.
- (4) A group of accent windows with an aggregate window size greater than 8 SF count as a window.
- (5) Corner break projections shall be a minimum of 2 feet in depth from the architectural plane which it is attached on both sides of the dwelling.

* The garage side of a home that faces the street on a corner lot shall be subject to the Secondary Architectural Plane requirement.

** Roof Ridge Line: A 2-story home shall require (i) 3 ridge lines and a 1st floor roof element with a minimum 2-foot projection or (ii) 4 ridge lines. Prairie style homes may have a lower roof pitch and fewer roof lines.

*** Sliding glass doors and French doors including a window shall count as windows. Doors without a window shall not count.

****Garage windows are required but do not otherwise count toward the required number of windows

EXHIBIT C-2

SINGLE FAMILY RESIDENTIAL ARCHITECTURAL STANDARDS

(Page 1 of 3)

The following standards shall apply to the development of the Real Estate in addition to the Architectural matrix (see **Exhibit C-1**).

- **Residential Character Imagery Exhibit:** “Residential Character Imagery”, is attached hereto as **Exhibit D**. Although the Residential Character Imagery does not represent the final home designs, it does hereby establish guidelines for the quality and appearance of homes, and it provides examples of specific design elements and development patterns that contribute to the intent and vision for the Real Estate.
- **Design Elements.** Design elements and detailing shall be continued completely around the structure, commonly known as “4-sided architecture”. Such design elements shall include, but are not limited to windows, window placement, roof overhangs, roof pitch, trim detailing, and exterior wall materials. The use of long, massive, unbroken exterior building walls shall be avoided. Multiple architectural elements (including but not limited to quoins, pilasters, soldier courses, lintels, friezes, cornices, dentils, architraves, wood or fiber cement siding varieties or breaks) are encouraged to achieve variation in terms of footprint and architectural elevations.
- **Corner Breaks.** Corner Breaks shall be a minimum of 2’ by 6’ creating an additional roof line. A corner lot street side is required to have the same number of corner breaks as the front elevations of the home. An additional corner break is required on homes that back to Little Chicago Road and Mill Creek Road (lots within one hundred (100) feet of the subject road right-of-way). Subject lots are identified on the Preliminary Development Plan, **Exhibit B**.
- **Exterior Surfaces.**
 - Aluminum and vinyl siding shall be prohibited; however, vinyl clad windows and soffits shall be permitted.
 - Permitted exterior materials may include cultured stone, brick, stone, wood, EIFS, synthetic stucco, fiber cement siding or comparable materials.
- **Windows and Architectural Breaks.**
 - Windows shall be provided on at least three (3) sides of the home; provided, however, that in the event a side façade does not have a window, then that facade shall have at least two (2) architectural breaks, such as a chimney or other corner break.

EXHIBIT C-2

SINGLE FAMILY RESIDENTIAL ARCHITECTURAL STANDARDS

(Page 2 of 3)


- Windows required herein shall be a minimum size of fifteen (15) square feet; or, windows less than fifteen (15) square feet each may meet this requirement if the collective size of multiple windows on a given facade is at least fifteen (15) square feet.
- Garage Orientation:
 - All Homes shall have a side load entry garage. A 3rd car garage may be front loaded provided it is a “Carriage Style” garage that is attached to the side of the home to the rear of the sideload garage doors providing a protruding garage in front of the front of the house. A maximum of fifty (50) percent of the homes on the Real Estate shall include a carriage style garage. The ARB may consider increasing this percentage in the future if requested.
- Masonry Requirements:
 - A minimum of a 24-inch wainscot but no higher than the first-floor windows is required on all 4 sides of the home. If the home is a lookout or walkout basement, the masonry wainscot shall stay at the same height as the top of the wainscot masonry area to the front and sides of the home.

EXHIBIT C-2

SINGLE FAMILY RESIDENTIAL ARCHITECTURAL STANDARDS

(Page 3 of 3)

- **Façade Variety Standards:**
 - The following Façade Variety Standards shall apply to ensure variations in home elevations and in the overall streetscape for single-family dwellings in the MonteClaire Planned Development:

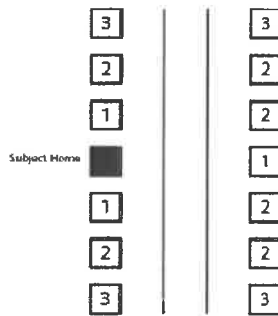

- 1** Homes shall be a different floor plan or model than subject home. At the time of the issuance of the Certificate of Occupancy, homes shall have a different primary siding color and at least one of the other three Color Package elements shall be a different color than the subject home.
- 2** Homes may have the same or variation of the same floor plan or model as the subject home; however, the home's front elevation may not be identical and shall incorporate multiple variations to the front elevation (e.g., entryway treatment, window style and treatment, building materials and patterns/textures, roofline treatment, garage door treatment or orientation). At the time of the issuance of the Certificate of Occupancy, homes shall have a different primary siding color and at least one of the other three Color Package elements shall be a different color than the subject home.
- 3** Homes may have the same or variation of the same floor plan or model as the subject home; however, the home's front elevation may not be identical. Homes may have the same primary siding color as the subject home; however, at least one Color Package element shall be a different color.

EXHIBIT D

Residential Character Imagery

(Page 1 of 4)



EXHIBIT D

Residential Character Imagery

(Page 2 of 4)



EXHIBIT D

Residential Character Imagery

(Page 3 of 4)



EXHIBIT D

Residential Character Imagery

(Page 4 of 4)



EXHIBIT E

Entrance Signage Exhibit

(Page 1 of 2)



EXHIBIT E

Entrance Signage Exhibit

(Page 2 of 2)

CAP DETAIL

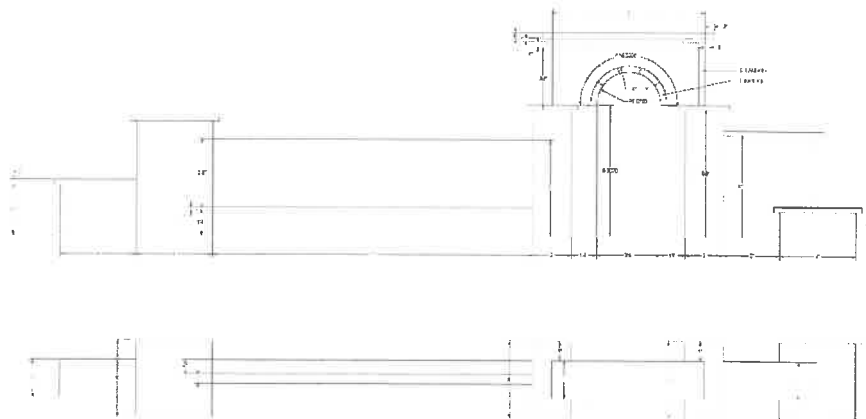
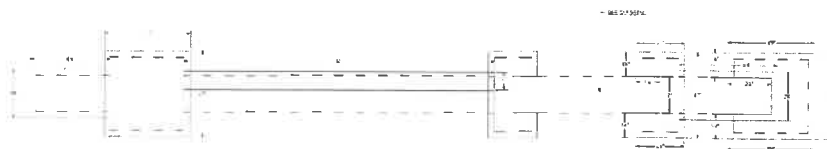
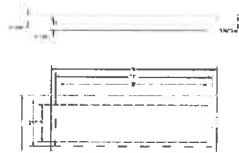


EXHIBIT F

Lot Landscaping Exhibit

(Page 1 of 2)

MontClaire of Noblesville Single Family Typical Landscaping


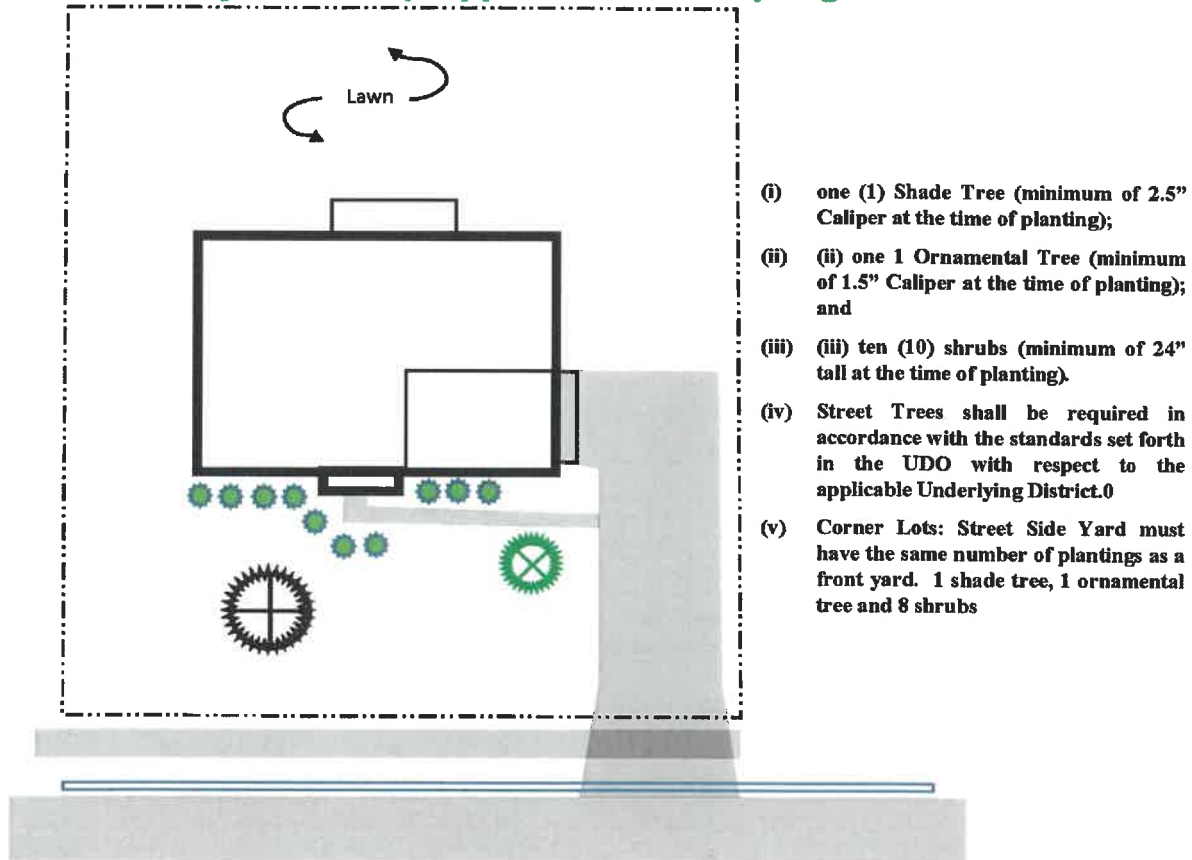


EXHIBIT F

Lot Landscaping Exhibit

(Page 2 of 2)

MontClaire of Noblesville Single Family Typical Landscaping (corner Lot)

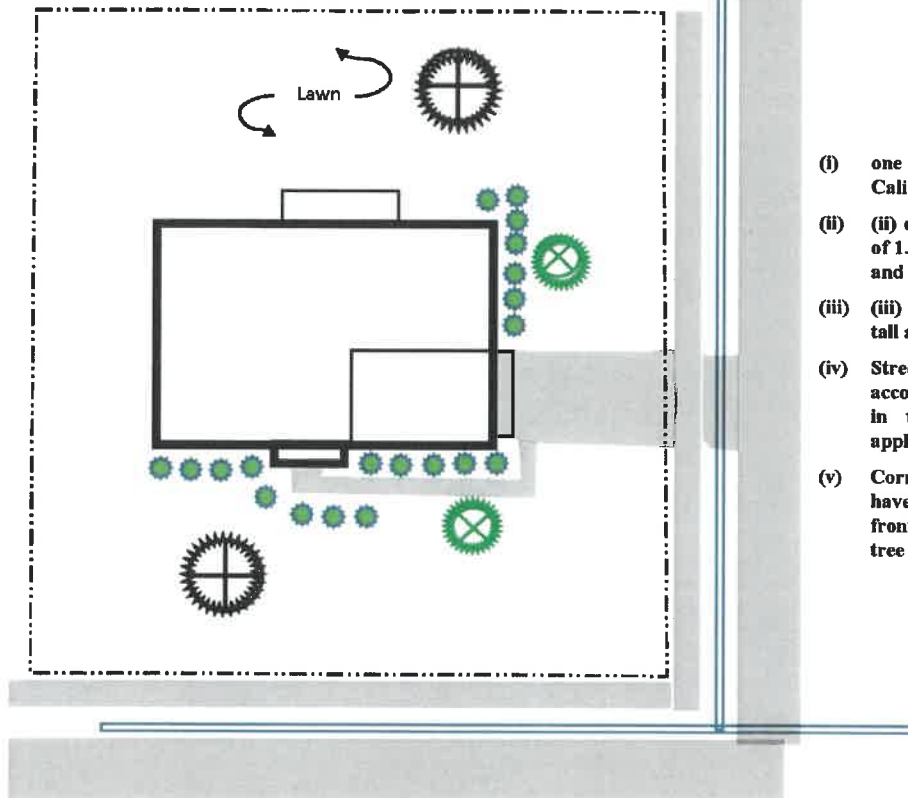

- (i) one (1) Shade Tree (minimum of 2.5" Caliper at the time of planting);
- (ii) one (1) Ornamental Tree (minimum of 1.5" Caliper at the time of planting); and
- (iii) ten (10) shrubs (minimum of 24" tall at the time of planting).
- (iv) Street Trees shall be required in accordance with the standards set forth in the UDO with respect to the applicable Underlying District.
- (v) Corner Lots: Street Side Yard must have the same number of plantings as a front yard. 1 shade tree, 1 ornamental tree and 8 shrubs

EXHIBIT G

Waivers

The below is a list of Waivers (intended to summarize the text of the PD Ordinance) from the underlying UDO standards.

- A. Modification of Minimum lot frontage, side setback, and maximum lot coverage bulk requirements (see Section 5).
- B. Lot Landscaping per **Exhibit F**.
- C. Reduction in the Buffer Yards due to legal drains, pipeline easements and resulting lot configuration.
- D. Amended sign standards to permit sign of the design (area and height) consistent with **Exhibit E**.
- E. Reduction of the minimum cul-de-sac radius to fifty-one (51) feet, street centerline radius and cul-de-sac length (see Section 11).